

LEGEND


- PROJECT LIMITS
- RSA RUNWAY SAFETY AREA
- ROFA RUNWAY OBJECT FREE AREA
- TSA TAXIWAY SAFETY AREA
- TOFA TAXIWAY OBJECT FREE AREA

PROJECT COORDINATE SYSTEM				
ALIGNMENT	POINT	STATION	NORTHING	EASTING
APRON	BOP	100+00.00	275847.0834	1985631.7065
	1	115+61.90	276230.7355	1986044.1735
ALPHA	EOP	119+80.00	276229.4090	1986463.6809
	BOP	200+00.00	275951.5733	1986462.8024
	EOP	219+00.00	276851.5641	1986465.6483

PROJECT BENCHMARKS				
NO.	NORTHING	EASTING	ELEVATION	DESCRIPTION
TOP B	278533.070	1985769.060	879.30	PRIMARY AIRPORT CONTROL POINT
TOP A 2004	277208.250	1987279.390	879.10	SECONDARY AIRPORT CONTROL POINT
AP STA B	275494.220	1989751.820	872.95	SECONDARY AIRPORT CONTROL POINT
PT 102	276467.982	1986098.305	879.59	1/2 IRON BAR W/ CP CAP
PT 103	276674.037	1986100.234	880.30	1/2 IRON BAR W/ CP CAP
PT 201	276351.870	1986045.772	880.27	SQUARE CUT

GENERAL NOTES:

- GRID COORDINATE SYSTEM: NAD83, KANSAS STATE PLANES, NORTH ZONE, US FOOT. VERTICAL DATUM: NORTH AMERICAN VERTICAL DATUM OF 1988 (NAVD 88), US FOOT.
- IT IS THE CONTRACTOR'S RESPONSIBILITY TO VERIFY CONTROL POINT INFORMATION PRIOR TO CONSTRUCTION. THE CONTRACTOR MUST REPORT TO MTA A ANY DISCREPANCIES FOUND DURING SURVEY VERIFICATIONS.
- CONTRACTOR SHALL PRESERVE AND PROTECT EXISTING CONTROL POINTS SHOWN ON PLAN. IF DAMAGED DURING CONSTRUCTION, CONTRACTOR SHALL RESTORE CONTROL POINTS.

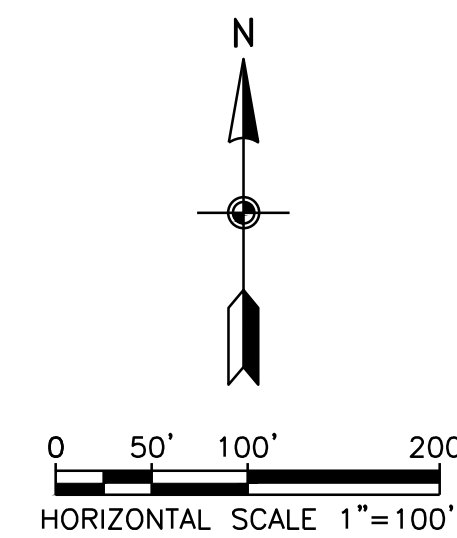

METROPOLITAN TOPEKA AIRPORT AUTHORITY

**PHILIP BILLARD MUNICIPAL AIRPORT
 TERMINAL APRON REHABILITATION**

AIP CONSTRUCTION GRANT NO. 3-20-0082-027
 BIL-AIG CONSTRUCTION GRANT NO. 3-20-0082-028

NO.	DATE	BY	DESCRIPTION

ISSUED FOR BID

LOCATION MAP AND ALIGNMENT CONTROL

DATE	FEBRUARY 14, 2025
SCALE	1" = 100'
DRAWN BY	BF
CHECKED BY	LDS
APPROVED BY	SFS

WSP PROJECT NUMBER US0040451.4453

SHEET NUMBER **GI1.01**

SHEET 3 OF 22

DESCRIPTION	LOCATION	ACRONYM	TOTAL WIDTH (FT)	DISTANCE FROM CL (FT)
TAXIWAY SAFETY AREA	A, C, D, E	TSA	79	39.5
TAXIWAY OBJECT FREE AREA	A, C, D, E	TOFA	124	62



LEGEND

- PHASE 1A
- PHASE 1B
- PHASE 2
- PHASE 3A
- PHASE 3B
- CONTRACTOR STAGING AREA
-
 FLAGPERSON
-
 ACCESS/HAUL ROUTE
-
 LOW PROFILE BARRICADE, SEE SHEET GC5.02
-
 RSA RUNWAY SAFETY AREA
-
 ROFA RUNWAY OBJECT FREE AREA
-
 TSA TAXIWAY SAFETY AREA
-
 TOFA TAXIWAY OBJECT FREE AREA



GENERAL CONTRACT NOTES:

1. THE CONTRACTOR SHALL PROVIDE A PROJECT SUPERINTENDENT WHO SHALL BE ON THE PROJECT SITE AT ALL TIMES WHILE WORK IS BEING PERFORMED TO SUPERVISE AND DIRECT THE CONSTRUCTION. THE PROJECT SUPERINTENDENT SHALL SERVE AS THE ON-PROJECT SAFETY COORDINATOR FOR THE CONTRACTOR AND BE EQUIPPED WITH A RADIO CAPABLE OF COMMUNICATING WITH THE AIR TRAFFIC CONTROL TOWER (ATCT) FOR THE PURPOSES OF RECEIVING INSTRUCTIONS AND OBTAINING CLEARANCES AS NEEDED. THIS RADIO IS FOR THE PROJECT SUPERINTENDENT'S EXCLUSIVE USE ONLY AND SHALL BE ON HIS PERSON AT ALL TIMES. THE SUPERINTENDENT SHALL BE THE 24 HOUR ON-CALL REPRESENTATIVE FOR EMERGENCY SITUATIONS. THE PROJECT SUPERINTENDENT SHALL BE RESPONSIBLE FOR SECURING PERMISSION FROM THE ATCT FOR CONSTRUCTION VEHICLES TO ENTER INTO AIRCRAFT MOVEMENT AREAS, WHEN NECESSARY, AND TO COMMUNICATE WITH THE ATCT DURING THE CONSTRUCTION FOR THE PROJECT. CONTRACTOR SHALL NOT ACCESS AIRCRAFT MOVEMENT AREA WITHOUT TOWER PERMISSION. GROUND CONTROL RADIO FREQUENCY IS 121.9 MHZ. TOWER CONTROL RADIO FREQUENCY IS 118.7 MHZ. GROUND FREQUENCY TO BE USED FOR A MAJORITY OF THE OPERATIONS. TOWER CONTROL FREQUENCY TO BE USED WHEN OCCUPYING A RUNWAY OPEN TO AIR TRAFFIC.
2. CONTRACTOR SUPERINTENDENT SHALL BE RESPONSIBLE FOR COMMUNICATING WITH THE ATCT IN THE EVENT THAT ACCESS TO AIRCRAFT MOVEMENT AREAS BECOME NECESSARY AND TO RECEIVE SPECIAL INSTRUCTIONS FROM THE ATCT IN THE CASE OF AN EMERGENCY.
3. CONTRACTOR SHALL BE RESPONSIBLE FOR COORDINATING MOVEMENT OF WORKERS WITHIN THE AIRCRAFT OPERATIONS AREA. THE DELIVERY OF MATERIALS TO THE PROJECT SITE AND THE ESCORTS FOR THOSE VEHICLES ONTO AND FROM THE PROJECT SITE THROUGH THE AIRCRAFT OPERATIONS AREA. ESCORT VEHICLES SHALL BE REQUIRED TO HAVE RADIO COMMUNICATION WITH THE TOWER AT ALL TIMES (SUPERINTENDENT'S RADIO IS NOT TO BE USED BY ESCORT VEHICLES). ALL WORK ASSOCIATED WITH PROJECT WILL BE PERFORMED AS BID AND TO THE LIMITS INDICATED BELOW.
4. ACCESS ROUTES FROM AND THROUGH THE APRON AREA SHALL BE ADEQUATELY DELINEATED WITH CONES AND/OR BARRICADES TO MARK TRAVEL ROUTES FOR DELIVERY VEHICLES AND TO PREVENT VEHICLES FROM STRAYING FROM DESIGNATED TRAVEL ROUTES.
5. TRAFFIC CONTROL DEVICES SHALL BE ERECTED TO CONTROL CONSTRUCTION TRAFFIC TO ONE AREA OF THE RAMP TO BE UTILIZED AS ACCESS ROADWAYS. MAXIMUM PATHWAY WIDTH IS 30'.
6. SPEED LIMIT ON HAUL ROUTES, ACTIVE APRONS AND TAXIWAYS AND RUNWAYS IS 20 MPH UNLESS OTHERWISE POSTED.
7. CONTRACTOR TO COORDINATE WITH MTA A GATE ACCESS TO STAGING AREA 2.
8. CONTRACTOR'S PERSONNEL WILL BE ALLOWED TO PARK PERSONAL VEHICLES IN STAGING AREA #1 & #2 DURING ALL PHASES
9. CONTRACTOR SHALL MAINTAIN CONTROL OF EQUIPMENT AND PERSONNEL AND PREVENT THE MOVEMENT OF THE SAME OUTSIDE OF THE PROJECT LIMITS AND/OR THROUGH ACTIVE AIRCRAFT OPERATION AREAS. ACTIVE AIRCRAFT OPERATION AREAS INCLUDE TAXIWAYS AND RUNWAYS NOT CLOSED DUE TO THE PROJECT REQUIREMENTS. FOR EXAMPLE, WHILE AIRCRAFT MAY BE MOVING ALONG OPEN TAXIWAYS, CONTRACTOR'S PERSONNEL WILL NOT BE PERMITTED TO ACCESS THESE OPEN TAXIWAYS WITHOUT SECURING PERMISSION FROM THE ATCT. CONTRACTOR EQUIPMENT, VEHICLES, AND PERSONNEL SHALL YIELD TO ALL AIRCRAFT MOVEMENT AND EMERGENCY EQUIPMENT. CONTRACTOR'S EQUIPMENT SHALL BE REMOVED FROM ROFA WHEN NOT IN USE.
10. THE NORMAL WORKDAY WILL OCCUR BETWEEN THE HOURS OF 7:00 AM AND 6:00 PM.

PHASING NOTES:

1. THE PROJECT MUST BE COMPLETED WITHIN 90 CALENDAR DAYS AFTER THE NOTICE TO PROCEED (NTP).

TRAFFIC CONTROL QUANTITIES				
PHASE	DESCRIPTION	LOCATION	UNITS	QUANTITY
1A	BARRICADES W/ LIGHTS	PCC APRON @ PHASE 1A SOUTH LIMIT	EACH	9
		PHASE 1A AND PHASE 2 LIMIT	EACH	8
		EDGE OF PHASE 1A & 1B LIMIT	EACH	33
1B	BARRICADES W/ LIGHTS	PCC APRON @ PHASE 1B SOUTH LIMIT	EACH	9
		PHASE 1B AND PHASE 2 LIMIT	EACH	6
		EDGE OF PHASE 1A & 1B LIMIT	EACH	33
		TXY ECHO @ TXY ALPHA TOFA	EACH	7
2	BARRICADES W/ LIGHTS	PHASE 2 SOUTH LIMIT	EACH	14
		PHASE 3 WORK LIMIT @ TXY ALPHA TOFA	EACH	15
3A	BARRICADES W/ LIGHTS	PHASE 2 EAST WORK LIMIT	EACH	18
		TXY ALPHA @ TXY DELTA TOFA	EACH	7
		TXY ALPHA @ MIDPOINT OF CONVENTIONAL HANGAR	EACH	17
3B	BARRICADES W/ LIGHTS	TXY ALPHA @ TXY CHARLIE TOFA	EACH	4
		TXY ALPHA @ MIDPOINT OF CONVENTIONAL HANGAR	EACH	17

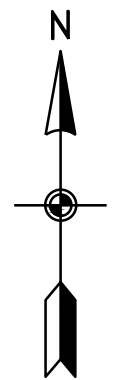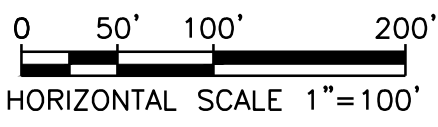

FILE NAME: US0040451.4453-GC0.01.DWG
PLOT DATE: Feb 12, 2025 - 1:25PM



METROPOLITAN TOPEKA AIRPORT AUTHORITY
PHILIP BILLARD MUNICIPAL AIRPORT
TERMINAL APRON REHABILITATION

AIP CONSTRUCTION GRANT NO. 3-20-0082-027
BIL-AIG CONSTRUCTION GRANT NO. 3-20-0082-028

NO.	DATE	BY	DESCRIPTION

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SHEET TITLE
CONSTRUCTION SAFETY & PHASING PLAN - OVERALL SHEET 1 OF 2


DATE: **FEBRUARY 14, 2025**
SCALE: **1" = 100'**
DRAWN BY: **BF**
CHECKED BY: **LDS**
APPROVED BY: **SFS**

WSP PROJECT NUMBER **US0040451.4453**

SHEET NUMBER **GC0.01**

SHEET **4 OF 22**

SCALE (S) AS NOTED ON THIS SHEET ARE BASED ON A FULL SIZE 22 X 34 SHEET

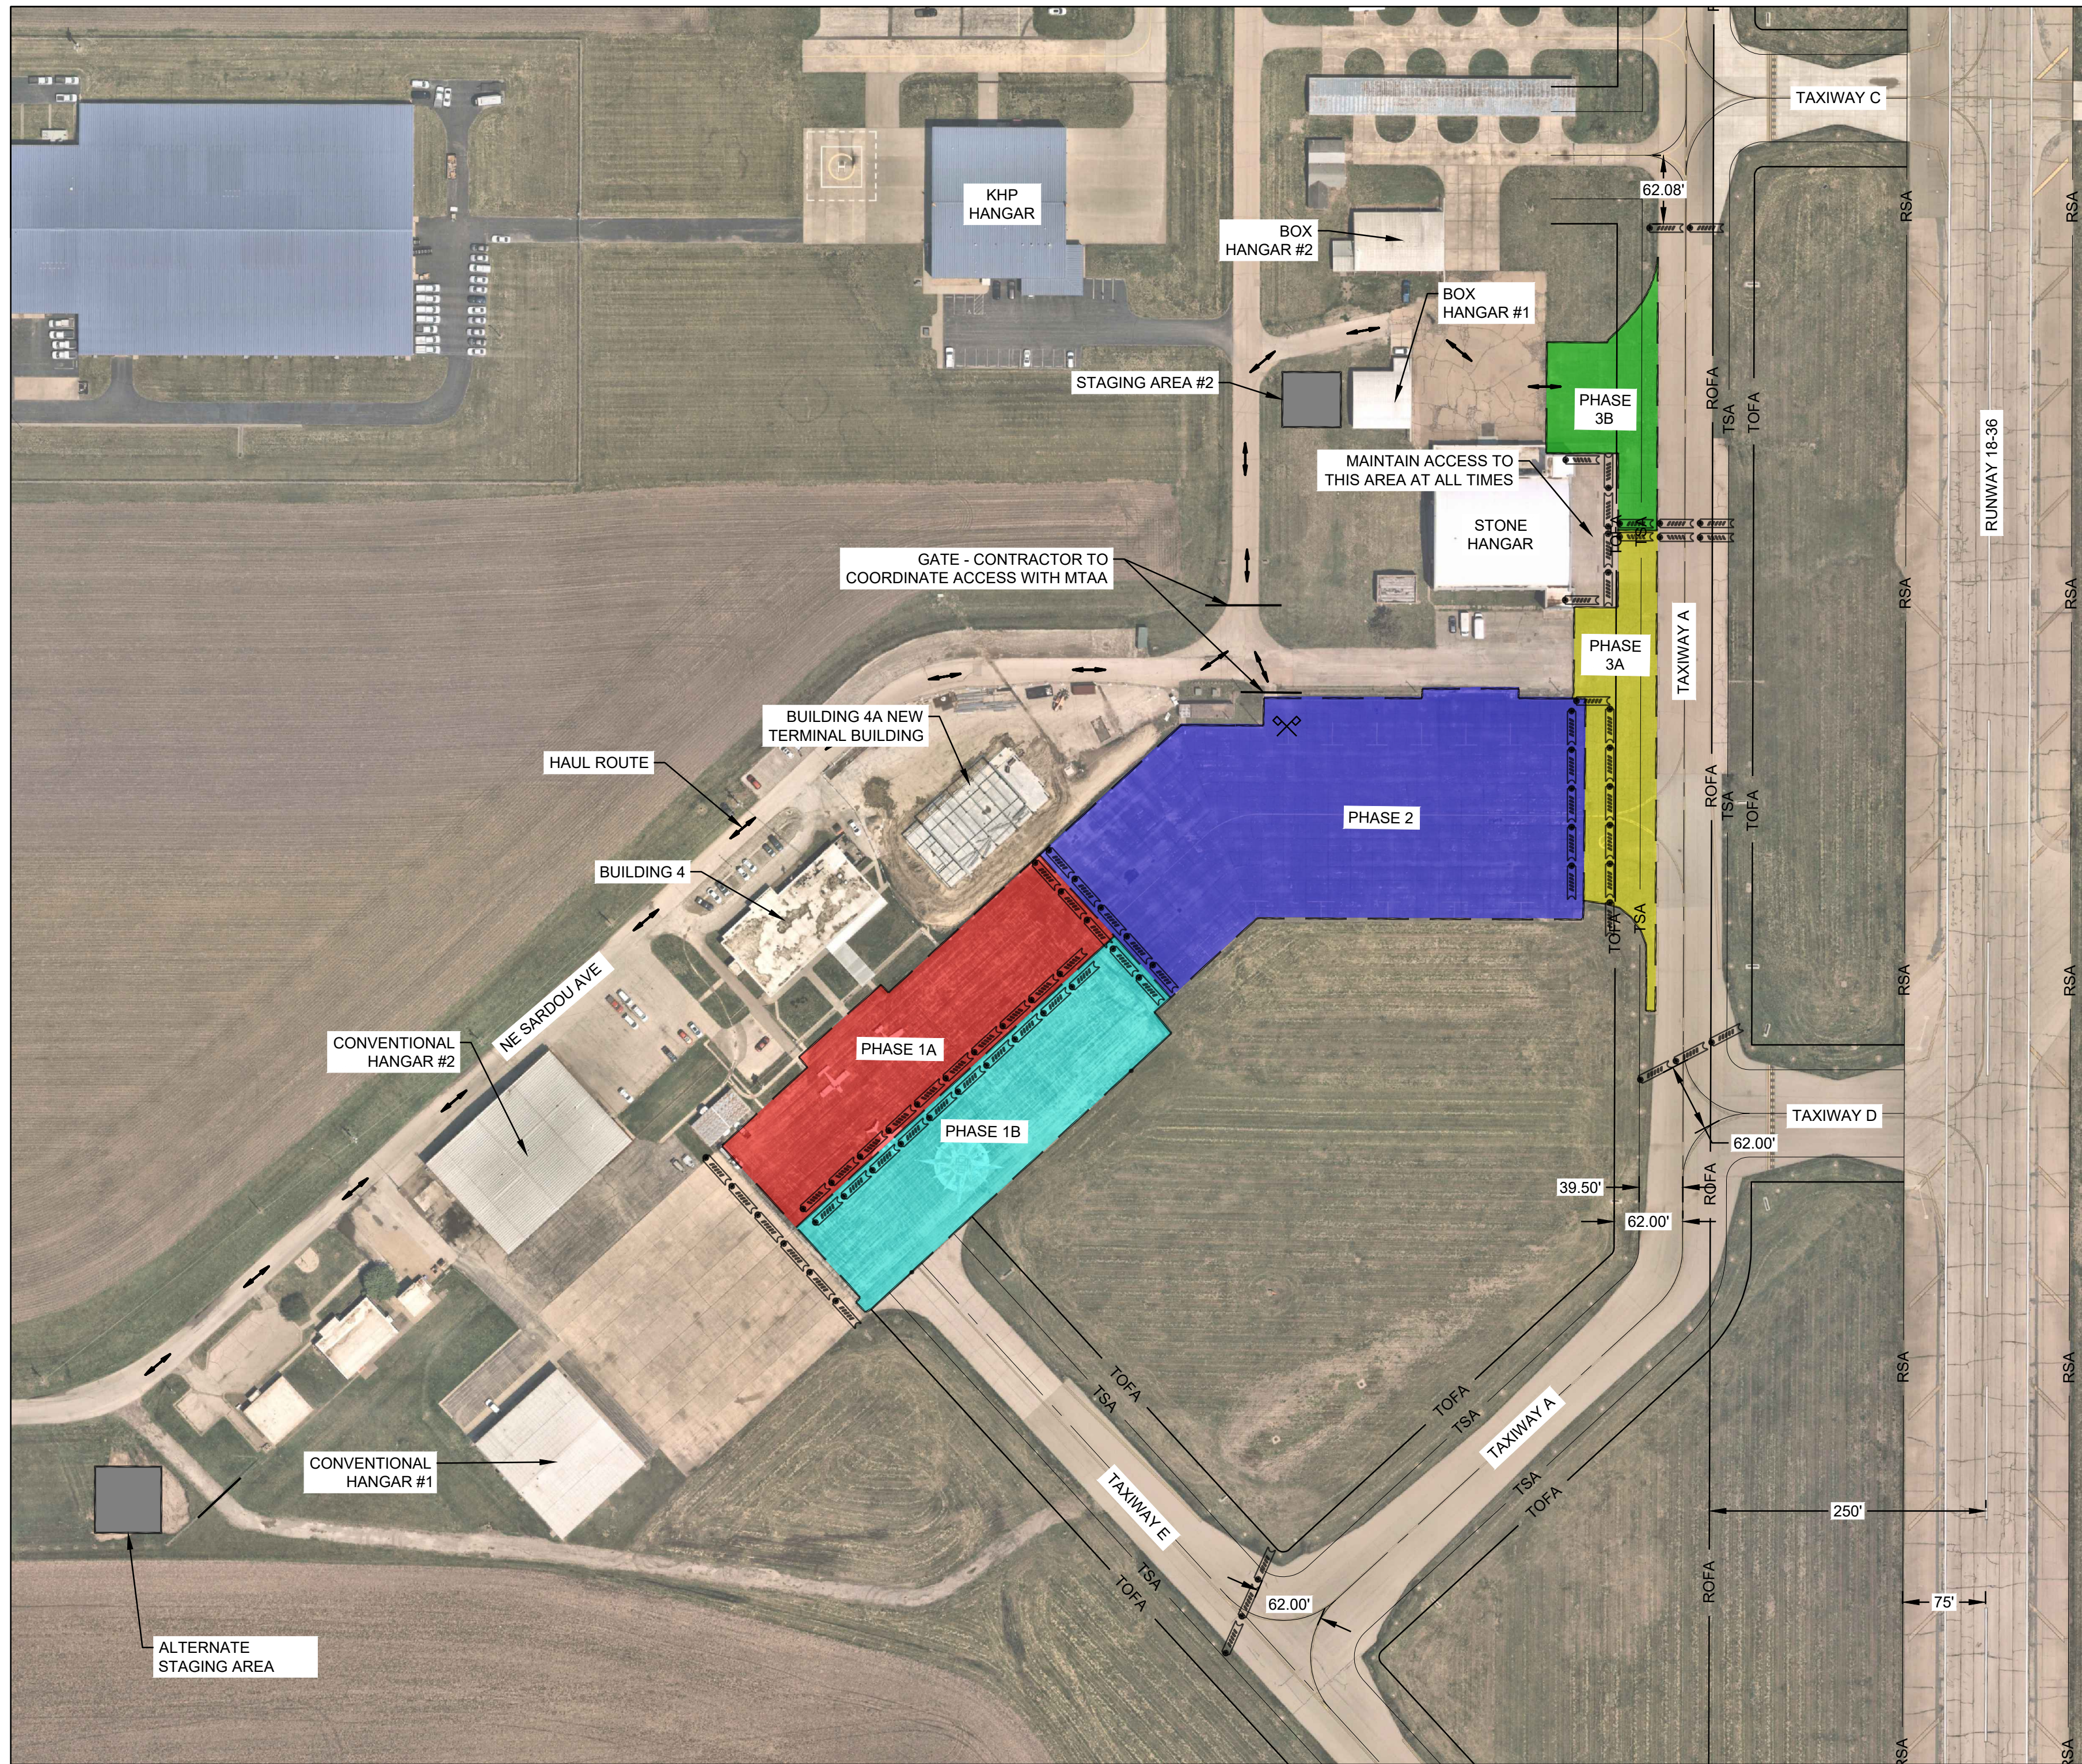

LEGEND

- PHASE 1A
- PHASE 1B
- PHASE 2
- PHASE 3A
- PHASE 3B
- CONTRACTOR STAGING AREA
- FLAGPERSON
- ACCESS/HAUL ROUTE
- LOW PROFILE BARRICADE, SEE SHEET GC5.02
- RSA RUNWAY SAFETY AREA
- ROFA RUNWAY OBJECT FREE AREA
- TSA TAXIWAY SAFETY AREA
- TOFA TAXIWAY OBJECT FREE AREA

PHASE 1A NOTES:

1. PHASE 1A (4,450 SY) WILL CONSIST OF:
 - 1.1. ISSUE NOTAMS FOR APRON CLOSURES
 - 1.2. SET UP OF LOW PROFILE BARRICADES
 - 1.3. SAWCUT PAVING LIMITS
 - 1.4. COMPLETE TIE-DOWN ABANDONMENT - TYPE 1
 - 1.5. MILL EXISTING ASPHALT PAVEMENT
 - 1.6. COMPLETE PCC JOINT AND CRACK REPAIRS
 - 1.7. COMPLETE CONCRETE REPAIRS
 - 1.8. COMPLETE ASPHALT PAVING
 - 1.9. TEMPORARY PAVEMENT MARKING APPLICATION
 - 1.10. COMPLETE SITE RESTORATION (TOPSOIL, SEEDING, ETC.)
 - 1.11. CLEAN PAVEMENT FOR AIRPORT/ENGINEER APPROVAL TO OPEN PHASE 1A AREA.
 - 1.12. REMOVE LOW PROFILE BARRICADES AND TAXIWAY EDGE LIGHT COVERS
2. TERMINAL APRON WITHIN WORK AREA 1A WILL BE CLOSED FOR THE DURATION OF PHASE 1A.
3. A FLAGPERSON MUST BE PROVIDED TRAFFIC CONTROL AT ENTRANCE GATES FOR THE DURATION OF WORK WITHING WORK AREA 1A
4. PHASE 1A MUST BE COMPLETED WITHIN 15 CALENDAR DAYS.

PHASE 1B NOTES:

1. PHASE 1B (4,300 SY) WILL CONSIST OF:
 - 1.1. ISSUE NOTAMS FOR APRON AND TAXIWAY CLOSURES
 - 1.2. SET UP OF LOW PROFILE BARRICADES
 - 1.3. COVER TAXIWAY EDGE LIGHTING WITHIN CLOSED TAXIWAY SECTIONS
 - 1.4. SAWCUT PAVING LIMITS
 - 1.5. COMPLETE TIE-DOWN ABANDONMENT - TYPE 1
 - 1.6. MILL EXISTING ASPHALT PAVEMENT
 - 1.7. COMPLETE PCC JOINT AND CRACK REPAIRS
 - 1.8. COMPLETE ASPHALT PAVING
 - 1.9. TEMPORARY PAVEMENT MARKING APPLICATION
 - 1.10. COMPLETE SITE RESTORATION (TOPSOIL, SEEDING, ETC.)
 - 1.11. CLEAN PAVEMENT FOR AIRPORT/ENGINEER APPROVAL TO OPEN PHASE 1B AREA.
 - 1.12. REMOVE LOW PROFILE BARRICADES AND TAXIWAY EDGE LIGHT COVERS
2. TAXIWAY ECHO WEST OF TAXIWAY ALPHA SHALL BE CLOSED FOR THE DURATION OF WORK WITHIN PHASE 1B
3. A FLAGPERSON MUST BE PROVIDED TRAFFIC CONTROL AT ENTRANCE GATES FOR THE DURATION OF WORK WITHING WORK AREA 1B
4. PHASE 1B MUST BE COMPLETED WITHIN 15 CALENDAR DAYS.

PHASE 2 NOTES:

1. PHASE 2 (10,050 SY) WILL CONSIST OF:
 - 1.1. ISSUE NOTAMS FOR APRON CLOSURES
 - 1.2. SET UP OF LOW PROFILE BARRICADES
 - 1.3. COMPLETE PCC JOINT AND CRACK REPAIRS
 - 1.4. COMPLETE TIE-DOWN ABANDONMENT - TYPE 2
 - 1.5. APPLY THERMOPLASTIC COAL TAR EMULSION
 - 1.6. TEMPORARY PAVEMENT MARKING APPLICATION
 - 1.7. COMPLETE SITE RESTORATION (TOPSOIL, SEEDING, ETC.)
 - 1.8. CLEAN PAVEMENT FOR AIRPORT/ENGINEER APPROVAL TO OPEN PHASE 2 AREA
 - 1.9. REMOVE LOW PROFILE BARRICADES
2. NO TAXIWAY CLOSURES ARE REQUIRED FOR THE DURATION OF WORK WITHIN THIS PHASE
3. PHASE 2 MUST BE COMPLETED WITHIN 15 CALENDAR DAYS.

PHASE 3A NOTES:

1. PHASE 3A (2,430 SY) WILL CONSIST OF:
 - 1.1. ISSUE NOTAMS FOR APRON AND TAXIWAY CLOSURES
 - 1.2. SET UP OF LOW PROFILE BARRICADES
 - 1.3. COVER TAXIWAY EDGE LIGHTING WITHIN CLOSED TAXIWAY SECTIONS
 - 1.4. SAWCUT PAVING LIMITS
 - 1.5. MILL EXISTING ASPHALT PAVEMENT
 - 1.6. COMPLETE ASPHALT PAVING
 - 1.7. TEMPORARY PAVEMENT MARKING APPLICATION
 - 1.8. CLEAN PAVEMENT FOR AIRPORT/ENGINEER APPROVAL TOP OPEN PHASE 3A AREA
 - 1.9. REMOVE LOW PROFILE BARRICADES AND TAXIWAY EDGE LIGHT COVERS
2. TAXIWAY ALPHA WILL BE CLOSED BETWEEN TAXIWAY D AND MIDPOINT OF ADJACENT STONE HANGAR. ADDITIONALLY, ACCESS TO THE APRON OFF OF TAXIWAY A WILL BE CLOSED FOR THE DURATION OF WORK WITH PHASE 3A
3. PHASE 3A MUST BE COMPLETED WITHIN 7 CALENDAR DAYS.

PHASE 3B NOTES:

1. PHASE 3B (1,540 SY) WILL CONSIST OF:
 - 1.1. ISSUE NOTAMS FOR APRON AND TAXIWAY CLOSURES
 - 1.2. SET UP OF LOW PROFILE BARRICADES
 - 1.3. COVER TAXIWAY EDGE LIGHTING WITHIN CLOSED TAXIWAY SECTIONS
 - 1.4. SAWCUT PAVING LIMITS
 - 1.5. MILL EXISTING ASPHALT PAVEMENT (490 SY)
 - 1.6. COMPLETE ASPHALT PAVING
 - 1.7. COMPLETE PCC JOINT AND CRACK REPAIR
 - 1.8. APPLY THERMOPLASTIC COAL TA EMULSION (1,050 SY)
 - 1.9. TEMPORARY PAVEMENT MARKING APPLICATION
 - 1.10. CLEAN PAVEMENT FOR AIRPORT/ENGINEER APPROVAL TOP OPEN PHASE 3B AREA
 - 1.11. REMOVE LOW PROFILE BARRICADES AND TAXIWAY EDGE LIGHT COVERS
2. TAXIWAY ALPHA WILL BE CLOSED BETWEEN TAXIWAY C AND MIDPOINT OF ADJACENT STONE HANGAR FOR THE DURATION OF WORK WITH PHASE 3B
3. PHASE 3A MUST BE COMPLETED WITHIN 7 CALENDAR DAYS.

METROPOLITAN TOPEKA AIRPORT AUTHORITY

PHILIP BILLARD MUNICIPAL AIRPORT

TERMINAL APRON REHABILITATION

AIP CONSTRUCTION GRANT NO. 3-20-0082-027
BIL-AIG CONSTRUCTION GRANT NO. 3-20-0082-028

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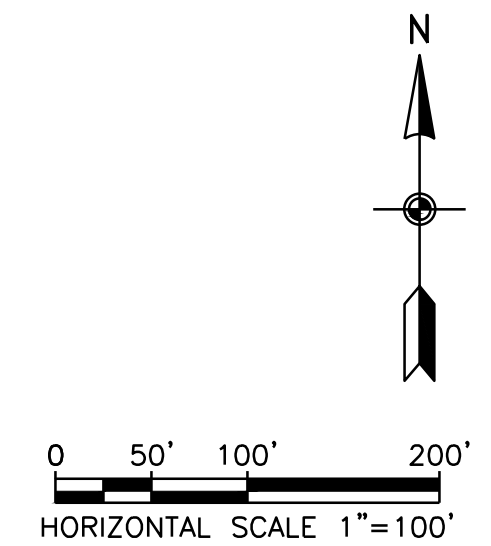
SHEET TITLE
CONSTRUCTION SAFETY & PHASING PLAN - OVERALL SHEET 2 OF 2

DATE **FEBRUARY 14, 2025**
SCALE **1" = 100'**
DRAWN BY **BF**
CHECKED BY **LDS**
APPROVED BY **SFS**

WSP PROJECT NUMBER **US0040451.4453**

SHEET NUMBER **GC0.02**

SHEET **5 OF 22**



8. NOTIFICATION OF CONSTRUCTION ACTIVITIES

- APPROPRIATE NOTICES TO AIRMEN (NOTAMS) MUST BE ISSUED PRIOR TO COMMENCING WORK ACTIVITIES IN THE VICINITY OF AIRCRAFT OPERATION AREAS. CONTRACTOR SHALL COORDINATE WORK ACTIVITIES AND PROJECT SCHEDULE WITH THE METROPOLITAN TOPEKA AIRPORT AUTHORITY (MTAA) AT LEAST 72 HOURS PRIOR TO EACH CHANGE IN CONSTRUCTION PHASING. MTAA SHALL COORDINATE ISSUANCE OF NOTAMS BASED UPON INFORMATION SUPPLIED BY THE CONTRACTOR. MTAA SHALL ISSUE NOTAMS AND CONFIRM THAT NOTAMS HAVE BEEN PUBLISHED. PRIOR TO MOVING INTO AIRCRAFT MOVEMENT AREAS TO ERECT TRAFFIC CONTROL, CONFIRMATION OF ISSUANCE OF NOTAMS WITH AIR TRAFFIC CONTROL TOWER SHALL BE MADE WHILE SECURING PERMISSION TO ENTER AIRCRAFT MOVEMENT AREAS.

EMERGENCY NOTIFICATION PROCEDURES

IDENTIFICATION AND QUALIFICATIONS OF A DEDICATED SECURITY AND SAFETY POINT OF CONTACT - THE CONTRACTOR PROJECT SUPERINTENDENT SHALL BE THE 24 HOUR ON-CALL REPRESENTATIVE.

FOR EMERGENCY SITUATIONS.

24 HOUR EMERGENCY CONTACTS FOR POLICE, FIRE, MEDICAL RESPONSE, AND KEY PROJECT PERSONNEL - THE CONTRACTOR SHALL PRODUCE AN EMERGENCY CONTACT LIST WITHIN 7 DAYS FOLLOWING THE PRE-CONSTRUCTION MEETING. AT A MINIMUM, THE FOLLOWING EMERGENCY CONTACTS SHALL BE INCLUDED ON THE CONTACT LIST:

CALL 911 FOR EMERGENCIES - FIRE / MEDICAL ASSISTANCE CALL 785-862-1130 FOR SECURITY RELATED ISSUES				
AGENCY	NAME	TITLE	PHONE	
METROPOLITAN TOPEKA AIRPORT AUTHORITY	SAFETY DEPARTMENT	EMERGENCY CALLS ONLY - POLICE & FIRE	(785) 862-1130	W
METROPOLITAN TOPEKA AIRPORT AUTHORITY	ERIC M. JOHNSON	PRESIDENT & DIRECTOR OF AIRPORTS	(785) 862-2362	W
METROPOLITAN TOPEKA AIRPORT AUTHORITY	COL. JOHN ROSS	CHIEF OF POLICE AND FIRE DEPARTMENT	(785) 862-2362	W
METROPOLITAN TOPEKA AIRPORT AUTHORITY	RITA EGGENBERGER	OPERATIONS OFFICER	(785) 862-0711	W
METROPOLITAN TOPEKA AIRPORT AUTHORITY	TERRY POLEY	DIRECTOR OF MAINTENANCE	(785) 862-0711	W
			(785) 633-9957	C
METROPOLITAN TOPEKA AIRPORT AUTHORITY	MATT ANSTAETT	DEPUTY DIRECTOR OF MAINTENANCE	(785) 862-0711	W
			(785) 633-0759	C
MIDWEST AIR TRAFFIC CONTROL SERVICES	COTE WERNER	AIR TRAFFIC CONTROL TOWER MANAGER	(785) 232-6015	W
WSP USA INC	SAM STALLBAUMER, PE	OWNER'S REPRESENTATIVE	(816) 702-4244	W
			(210) 867-6532	C

9. INSPECTION REQUIREMENTS

- DAILY INSPECTIONS
 - THE CONTRACTOR IS RESPONSIBLE FOR QUALITY CONTROL INSPECTION OF HIS/HER OWN WORK, AS WELL AS FOR ALL SAFETY REQUIREMENTS FOR THE PROJECT. THE CONTRACTOR IS REQUIRED TO ADHERE TO THE CONTRACT DOCUMENTS, WHICH INCLUDE ALL SAFETY REQUIREMENTS OF THIS SAFETY AND PHASING PLAN. INSPECTIONS OF THE WORK ZONE CONES/BARRICADES, STOCKPILE AREAS, EQUIPMENT, EROSION/SEDIMENT CONTROL DEVICES AND ADJACENT SURFACES SHALL OCCUR ON A DAILY BASIS TO ENSURE ALL CONDITIONS MEET THE REQUIREMENTS SPECIFIED WITHIN THIS SAFETY & PHASING PLAN AND THE CONTRACT DOCUMENTS. THE CONTRACTOR WILL ALSO BE RESPONSIBLE FOR ANY INSPECTIONS OF MOVEMENT AREAS PRIOR TO THE AREA BEING OPENED FOR ANY AIRCRAFT. IT IS THE CONTRACTOR'S RESPONSIBILITY TO ADDRESS CONSTRUCTION SAFETY ISSUES ADJACENT OR INCIDENTAL TO THE PROJECT, EVEN IF THEY ARE NOT DIRECTLY RELATED TO THIS PROJECT.
- FINAL INSPECTIONS
 - ANY DAMAGE ALONG THE HAUL ROUTES SHALL BE REPAIRED BY THE CONTRACTOR PRIOR TO THE COMPLETION OF THE PHASE FOR WHICH THE ROUTE IS USED. ALL HAUL ROUTES AND WORK AREAS SHALL BE INSPECTED BY CONTRACTOR/OWNER'S REPRESENTATIVE/MTAA PRIOR TO ANY PAVEMENT SECTION BEING RE-OPENED TO AIRCRAFT OR THE TRAVELING PUBLIC. THE CONTRACTOR SHALL PERFORM A FINAL INSPECTION OF ALL HAUL ROUTES NEAR THE COMPLETION OF PHASE 2 WITH ANY DEFECTS BEING REPAIRED AS BEING A CONDITION FOR SUBSTANTIAL COMPLETION FOR THE PROJECT.

10. UNDERGROUND UTILITIES

- PROCEDURE FOR LOCATING AND PROTECTING EXISTING UNDERGROUND UTILITIES, CABLES, AND WIRES:
 - PRIOR TO CONSTRUCTION, THE CONTRACTOR SHALL WALK THE JOB SITE WITH THE OWNER, AIRPORT OPERATIONS AND FAA TECHNICAL SERVICES TO IDENTIFY ANY EXISTING UNDERGROUND UTILITIES, CABLES, AND WIRES.
 - THE CONTRACTOR SHALL VERIFY, IDENTIFY, LOCATE, MARK OUT, AND PROTECT THE ACTUAL LOCATIONS OF UTILITIES PRIOR TO ANY EXCAVATION. WHEN AT ALL FEASIBLE, THE CONTRACTOR WILL MARK EXISTING UTILITIES IN THE MOVEMENT AREA.
 - THE CONTRACTOR SHALL COORDINATE WITH ALL APPROPRIATE AGENCIES.
 - THE CONTRACTOR SHALL HAND-DIG WHEN WITHIN 3 FEET OF ANY KNOWN OR SUSPECTED UTILITY.
 - THE CONTRACTOR SHALL PROTECT ALL UNDERGROUND UTILITIES DURING THE DURATION OF THE PROJECT.

11. PENALTIES

- IN THE EVENT AN EMPLOYEE OF THE CONTRACTOR VIOLATES A SAFETY PROVISION, THEY SHALL BE PROHIBITED FROM RETURNING TO WORK ON THE AOA WITHOUT REMEDIAL SAFETY TRAINING AND THE APPROVAL OF THE AIRPORT. VIOLATIONS MAY BE DEEMED AS JUST AND SUFFICIENT CAUSE TO REQUIRE THE EMPLOYEE BE PERMANENTLY REMOVED FROM THE JOB SITE AT THE DISCRETION OF THE AIRPORT. SHOULD VIOLATIONS BY CONTRACTOR PERSONNEL BE SUBJECT TO FINES AS ASSESSED BY THE FEDERAL AVIATION ADMINISTRATION, THE CONTRACTOR SHALL BE RESPONSIBLE FOR THE PAYMENT OF SAID FINES AND THE REMOVAL OF THE EMPLOYEE RESPONSIBLE FOR THE VIOLATION TO BE REMOVED FROM THE PROJECT SITE PERMANENTLY.
- THE CONTRACTOR SHALL BE RESPONSIBLE FOR ALL COSTS AND DELAYS CAUSED BY A SAFETY VIOLATION(S). CONSTRUCTION PERSONNEL DRIVING ERRATICALLY ON THE AIRPORT, EXCEEDING THE 20 MPH SPEED LIMIT, OR VIOLATING ANY OTHER AIRPORT DRIVING RULE OR SAFETY REGULATION, AT A MINIMUM, SHALL BE REMOVED FROM THE PROJECT PERMANENTLY. AIRPORT OPERATIONS CAN REMOVE ANY CONTRACTOR PERSONNEL, AT ANY TIME, FOR ANY DURATION, DUE TO A SAFETY VIOLATION. AIRPORT OPERATIONS SHALL REPORT ANY OCCURRENCES TO THE CONTRACTOR AND THE OWNER.

12. SPECIAL CONDITIONS

- ALL CONTRACTOR'S SUPERVISORY PERSONNEL (PROJECT MANAGERS, SUPERINTENDENTS, FOREMEN, AND LEAD WORKERS) WHO WILL BE DIRECTING THE PROJECT WORK, WHO WILL BE DRIVING EQUIPMENT ON THE AIRFIELD, OR ESCORTING OTHERS ON THE AIRFIELD SHALL BE REQUIRED TO TAKE AND PASS THE MTAA PEDESTRIAN/FLIGHT LINE DRIVING COURSE OF INSTRUCTION. TRUCK DRIVERS AND EQUIPMENT OPERATORS WHO WILL BE DRIVING STRICTLY WITHIN THE CONFINES OF THE HAUL ROUTES AND THE PROJECT AREA WILL NOT BE REQUIRED TO TAKE THIS TRAINING COURSE. THOSE DRIVERS OR OPERATORS WHO WILL BE DRIVING OUTSIDE OF THE HAUL ROUTES OR PROJECT LIMITS WILL BE REQUIRED TO TAKE AND PASS THE TRAINING COURSE. THIS COURSE OF INSTRUCTION LASTS APPROXIMATELY 1-2 HOURS AND WILL BE PROVIDED BY THE MTAA TO CONTRACTOR'S PERSONNEL AT NO COST TO THE CONTRACTOR. CONTRACTOR WILL ATTEMPT TO PROVIDE PERSONNEL FOR TRAINING IN GROUPS SO AS TO MINIMIZE THE NUMBER OF TRAINING SESSIONS. TRAINING SESSIONS SHALL BE COORDINATED WITH RITA EGGENBERGER, OPERATIONS OFFICER, 785-862-0399.
- CONTRACTOR SHALL BE RESPONSIBLE FOR PROVIDING ESCORT VEHICLES/PERSONNEL TO PROVIDE ESCORT FOR ASPHALT DELIVERY TRUCKS, CONCRETE READY-MIX TRUCKS OR OTHER VEHICLES THAT WILL DELIVER FRESH MATERIALS TO OR REMOVE MATERIALS FROM THE WORK SITE WITHIN THE AOA OR HAULING AWAY MATERIALS FROM THE AOA TO BE DISPOSED AT OFFSITE LOCATIONS. MTAA SAFETY PERSONNEL SHALL PROVIDE TRAINING FOR CONTRACTOR'S PERSONNEL AT THE ONSET OF THE PROJECT TO PROVIDE ESCORT AND AIRFIELD MOVEMENT TRAINING.

13. APRON, RUNWAY AND TAXIWAY VISUAL AIDS

- GENERAL
 - CLOSURES SHALL BE NOTED WITH THE USE OF LOW PROFILE BARRICADES AT APRON AND TAXIWAY CROSSINGS. BARRICADES SHALL BE SECURED TO PREVENT MOVEMENT FROM JET BLAST. THE AIRPORT WILL PROVIDE NOTAMS FOR CLOSURES AND THE CONTRACTOR WILL BE REQUIRED TO PROVIDE, PLACE AND MAINTAIN TEMPORARY BARRICADES AT CLEARLY VISIBLE LOCATIONS TO KEEP PILOTS FROM ERRANTLY TAXIING DOWN A CLOSED APRON OR CLOSED TAXIWAY. LOW PROFILE BARRICADES ARE TO BE PLACED AT THE RSA BOUNDARY.
- LIGHTING AND VISUAL NAVAIDS
 - IF CLOSURES ARE REQUIRED, CLOSED TAXIWAY EDGE LIGHTS AND GUIDANCE SIGNAGE SHALL BE COVERED TO FURTHER ELIMINATE THE POSSIBILITY OF CONFUSING A PILOT. LIGHTING ACTIVITIES SHALL COMPLY WITH CURRENT FAA ADVISORY CIRCULAR 150/5340-30H "DESIGN AND INSTALLATION DETAILS FOR AIRPORT VISUAL AIDS", AC 150/5345-50B "SPECIFICATION FOR PORTABLE RUNWAY AND TAXIWAY LIGHTS" AND AC 150/5345-53D "AIRPORT LIGHTING EQUIPMENT CERTIFICATION PROGRAM".
- SIGNS
 - GUIDANCE SIGNAGE SHALL BE COVERED TO FURTHER ELIMINATE THE POSSIBILITY OF CONFUSING A PILOT. SIGNS MUST BE IN CONFORMANCE WITH CURRENT FAA ADVISORY CIRCULAR 150/5345-44K "SPECIFICATION FOR RUNWAY AND TAXIWAY SIGNS", AC 150-5340-18F "STANDARDS FOR AIRPORT SIGN SYSTEMS" AND AC 150/5345-53D "AIRPORT LIGHTING EQUIPMENT CERTIFICATION PROGRAM".
 - DO NOT COVER TAXIWAY DIRECTIONAL SIGNS THAT LEAD TO CLOSED TAXIWAYS.

14. MARKING AND SIGNS FOR ACCESS ROUTES

- THE ACCESS ROADS USED FOR HAULING AND DELIVERY OF MATERIALS TO THE SITE SHALL BE MARKED WITH TEMPORARY GUIDANCE SIGNS (STAKE MOUNTED OR SAW-HORSE, WEIGHTED DOWN WITH SAND BAGS) CONFORMING TO CURRENT FAA ADVISORY CIRCULAR 150/5345-44K, AC 150/5340-18F, MANUAL ON UNIFORM TRAFFIC CONTROL DEVICES (MUTCD) OR STATE HIGHWAY DEPARTMENT REQUIREMENTS. AT ALL ENTRANCES TO THE AOA, SPEED LIMIT SIGNS (20 MPH) SHALL BE PLACED. STOP SIGNS AND DIRECTION ARROW SIGNS SHALL BE PLACED AT KEY POINTS ALONG THE ACCESS ROAD TO ENSURE THE CONTRACTOR VEHICLES DRIVING THE ROUTE ADHERE TO YIELDING ALL AIRCRAFT THE RIGHT-OF-WAY AT ALL TIMES AND MINIMIZING POTENTIAL FOR ACCIDENTS OR ERRANTLY DRIVING OFF THE ROUTE.

15. HAZARD MARKING AND LIGHTING

- CONTRACTOR SHALL BE RESPONSIBLE FOR THE TRAFFIC CONTROL USED DURING THE COURSE OF THE PROJECT. CONTRACTOR SHALL FURNISH, INSTALL, MAINTAIN AND DISMANTLE ALL TRAFFIC CONTROL ITEMS USED DURING COURSE OF THE PROJECT. BARRICADES AROUND AIRCRAFT MOVEMENT AREAS MUST BE LOW PROFILE, LOW MASS BARRICADES SIMILAR TO THAT SHOWN ON SHEET C1.1.3.
- ALL VEHICLES AND EQUIPMENT THAT WILL BE CROSSING OR OPERATING IN THE AIR OPERATIONS AREAS OR ON ANY ACTIVE APRON OR TAXIWAY, AIRCRAFT MOVEMENT AREAS AND RUNWAY SAFETY AREAS SHALL BE MARKED WITH EITHER A FLAG OR A FLASHING BEACON. THE FLAGS (DAYTIME USE) SHALL BE ON A STAFF ATTACHED TO THE VEHICLE, 3-FOOT SQUARE WITH ORANGE AND WHITE CHECKERED PATTERN. BEACONS SHALL BE OF ADEQUATE SIZE AND STRENGTH AS TO BE VISIBLE FROM THE AIR AND MOUNTED ON THE UPPERMOST PART OF THE VEHICLE. ALL VEHICLES OPERATING DURING NIGHTTIME OPERATIONS SHALL BE EQUIPPED WITH A FLASHING AMBER BEACON.

16. PROTECTION

- NO WORK SHALL OCCUR WITHIN A TOFA OF AN OPEN TAXIWAY.
- ACTIVITIES SHOULD BE CONFINED TO AN AREA OR WORK ZONE SUCH THAT TRENCHES, OPEN EXCAVATIONS, AND CLEANING OPERATIONS CAN BE PERFORMED IN A RELATIVELY SHORT PERIOD OF TIME PRIOR TO THE END OF THE WORK DAY.
- ALL CONTRACTOR'S AND SUBCONTRACTORS' VEHICLES, PERSONNEL AND EQUIPMENT SHALL BE CONFINED TO THE LIMITS OF THE CONSTRUCTION PHASES, OCCUPYING ONLY THE PHASE WHERE WORK IS IN PROGRESS.

17. OTHER LIMITATIONS ON CONSTRUCTION

- FLARE POTS AND BLASTING ARE PROHIBITED FROM USE ON THIS PROJECT.
- OPEN FLAME WELDING, WITH ADEQUATE FIRE SAFETY PRECAUTIONS, WILL BE ALLOWED.
- BLASTING IN NOT ANTICIPATED FOR THE PROJECT AND WILL NOT BE ALLOWED.



METROPOLITAN TOPEKA AIRPORT AUTHORITY

PHILIP BILLARD MUNICIPAL AIRPORT
TERMINAL APRON REHABILITATION

AIP CONSTRUCTION GRANT NO. 3-20-0082-027
BILL-AIG CONSTRUCTION GRANT NO. 3-20-0082-028

NO.	DATE	BY	DESCRIPTION																	

ISSUED FOR BID


SHEET TITLE
CONSTRUCTION SAFETY & PHASING PLAN NOTES
SHEET 2 OF 2

DATE **FEBRUARY 14, 2025**
SCALE **NTS**
DRAWN BY **BF**
CHECKED BY **LDS**
APPROVED BY **SFS**

WSP PROJECT NUMBER **US0040451.4453**

SHEET NUMBER **GC0.04**

SHEET **7 OF 22**

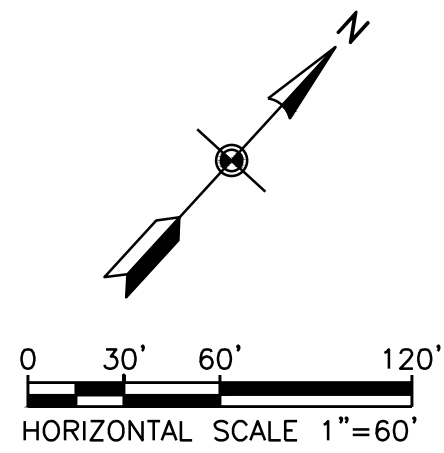


LEGEND

- 1.5" DEPTH MILL BITUMINOUS ASPHALT (ITEM P-101-5.2). JOINT AND CRACK REPAIR OF EXISTING CONCRETE (ITEM P-101-5.1)
- 3" DEPTH MILL BITUMINOUS ASPHALT (ITEM P-101-5.2). JOINT AND CRACK REPAIR OF EXISTING CONCRETE (ITEM P-101-5.1)
- THERMOPLASTIC COAL TAR EMULSION SURFACE PREPARATION (ITEM P-629-8.1). JOINT AND CRACK REPAIR OF EXISTING CONCRETE (ITEM P-101-5.1)

- EXISTING PERIMETER FENCE
- EXISTING EDGE OF PAVEMENT

NOTES:

1. SAWCUT ALONG THE PERIMETER OF MILLED AREA. SAWCUT DEPTH TO EQUAL MILLED DEPTH.

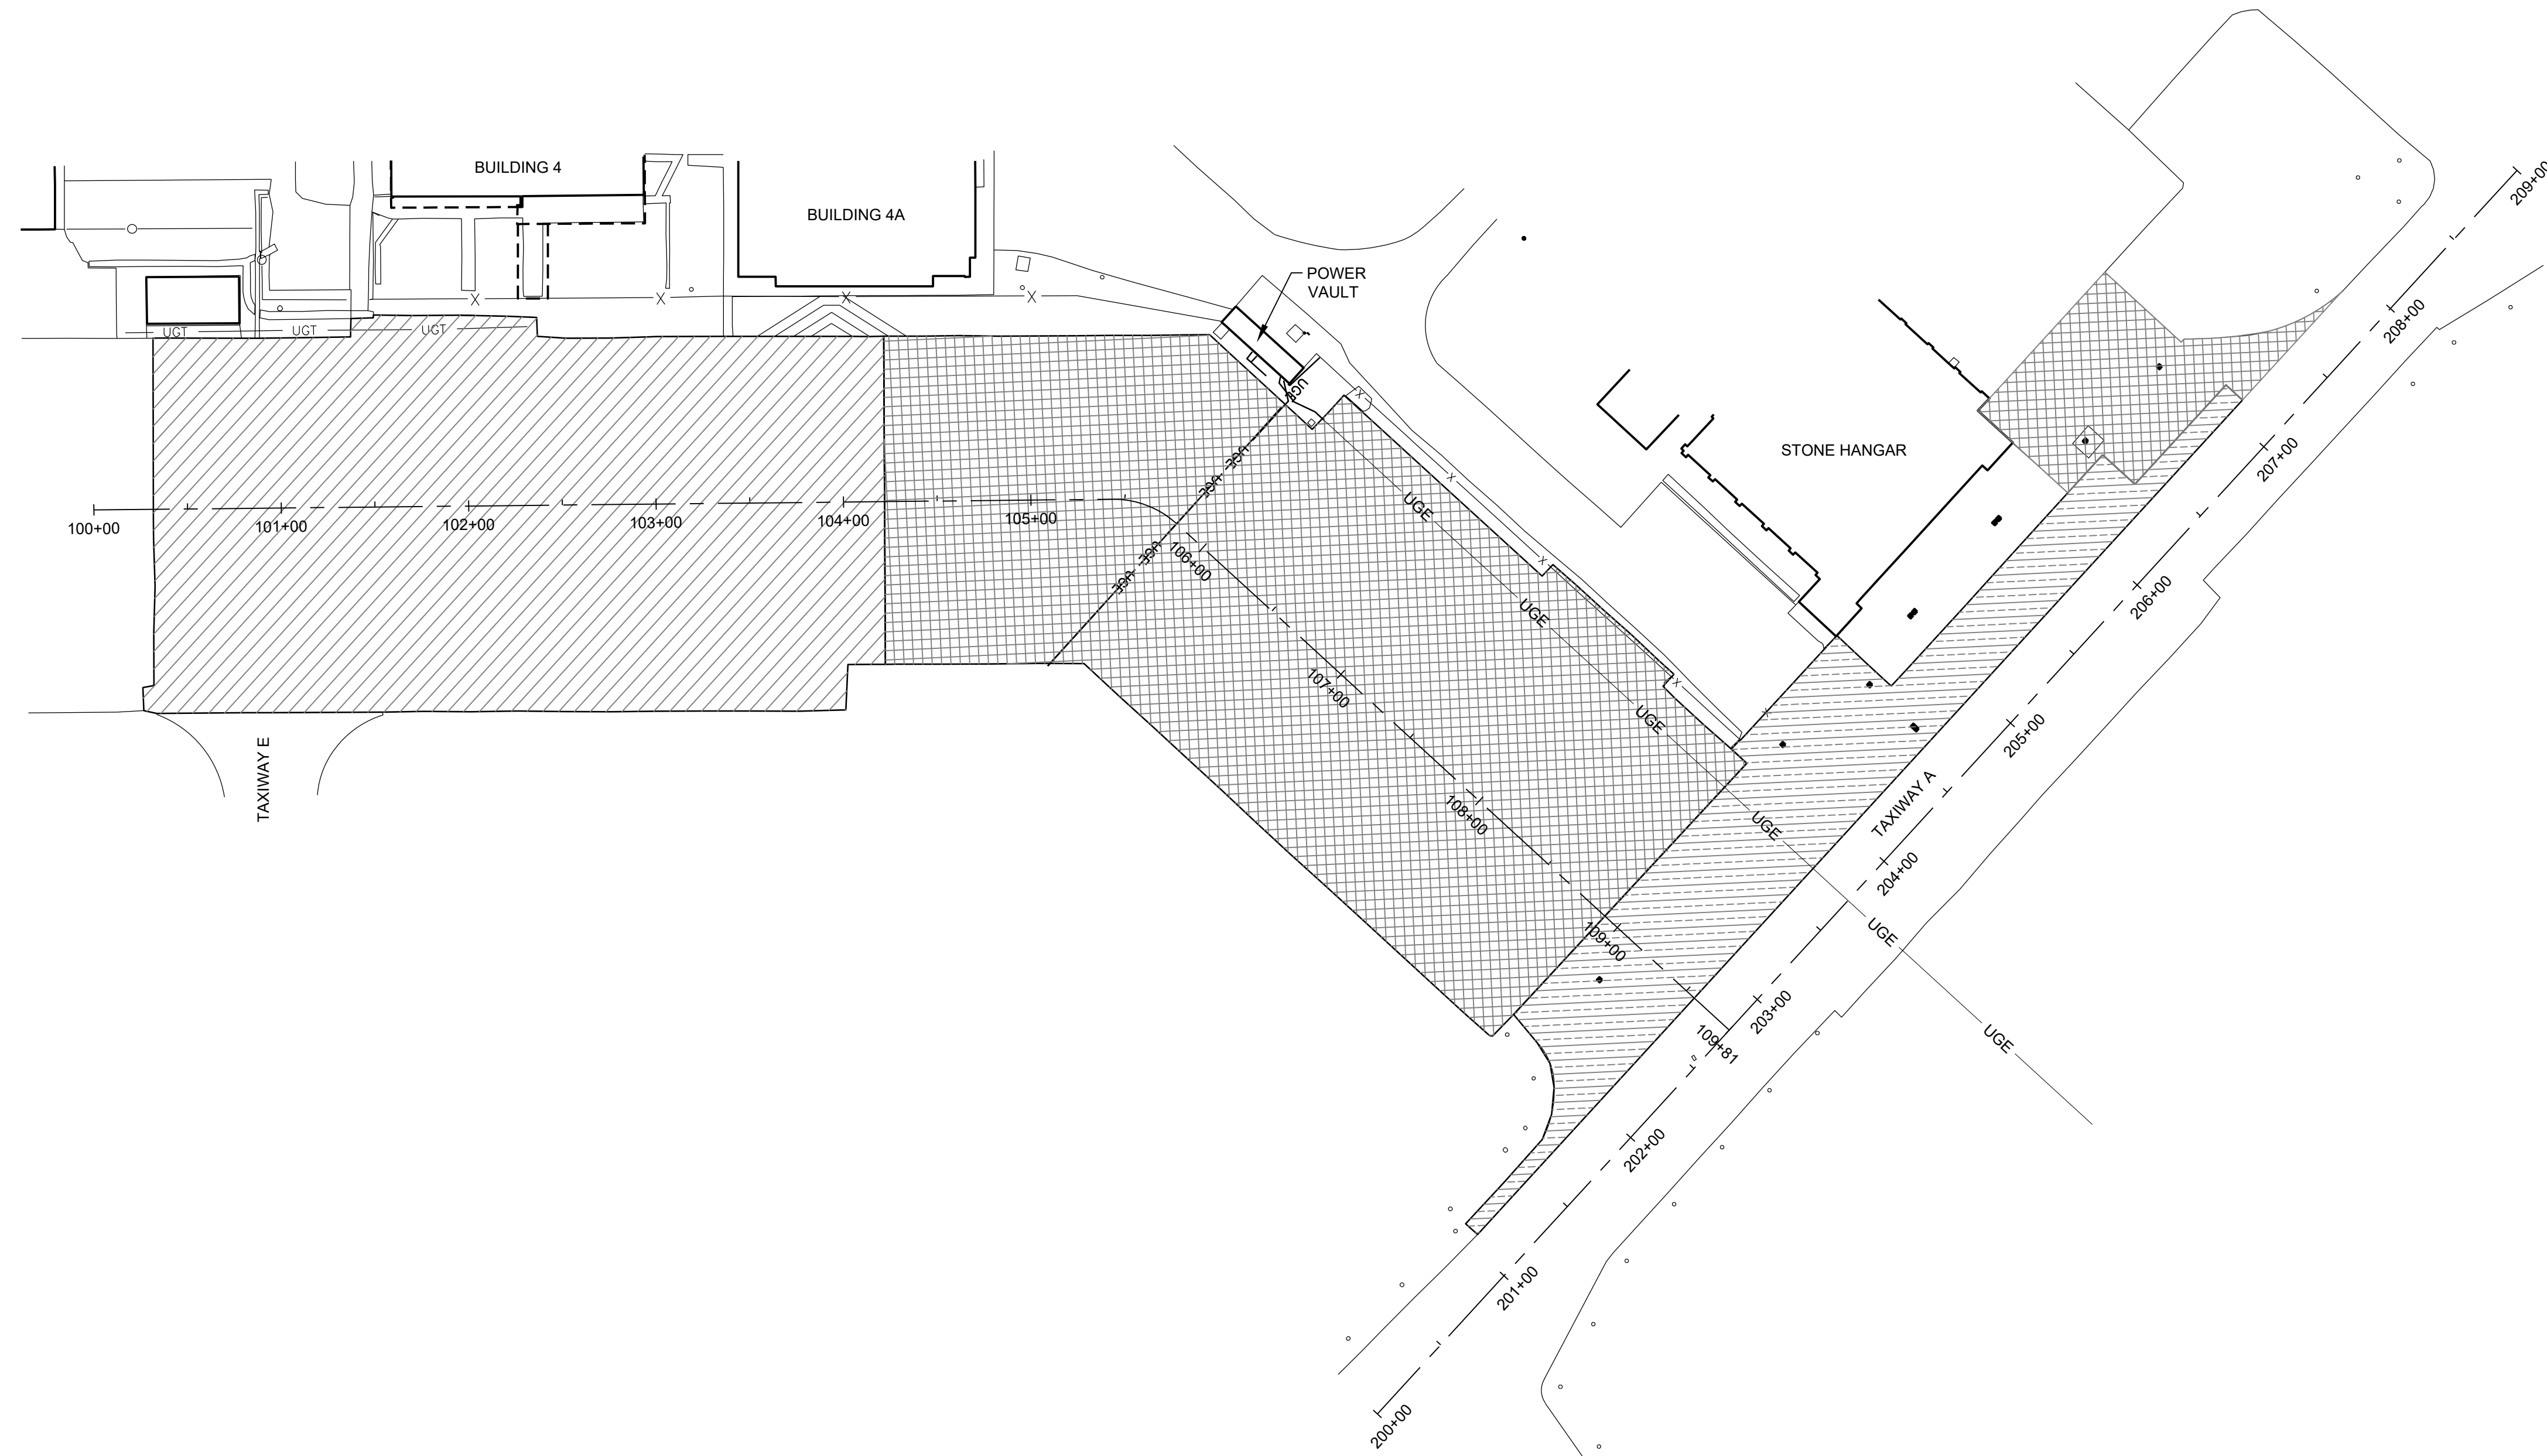

METROPOLITAN TOPEKA AIRPORT AUTHORITY

**PHILIP BILLARD MUNICIPAL AIRPORT
TERMINAL APRON REHABILITATION**

AIP CONSTRUCTION GRANT NO. 3-20-0082-027
BIL-AIG CONSTRUCTION GRANT NO. 3-20-0082-028

NO.	DATE	BY	DESCRIPTION

ISSUED FOR BID



SHEET TITLE
**DEMOLITION PLAN
SHEET 1 OF 3**

DATE **FEBRUARY 14, 2025**
SCALE **1" = 60'**
DRAWN BY **BF**
CHECKED BY **LDS**
APPROVED BY **SFS**

WSP PROJECT NUMBER **US0040451.4453**

SHEET NUMBER **CD1.01**

SHEET **11** OF **22**

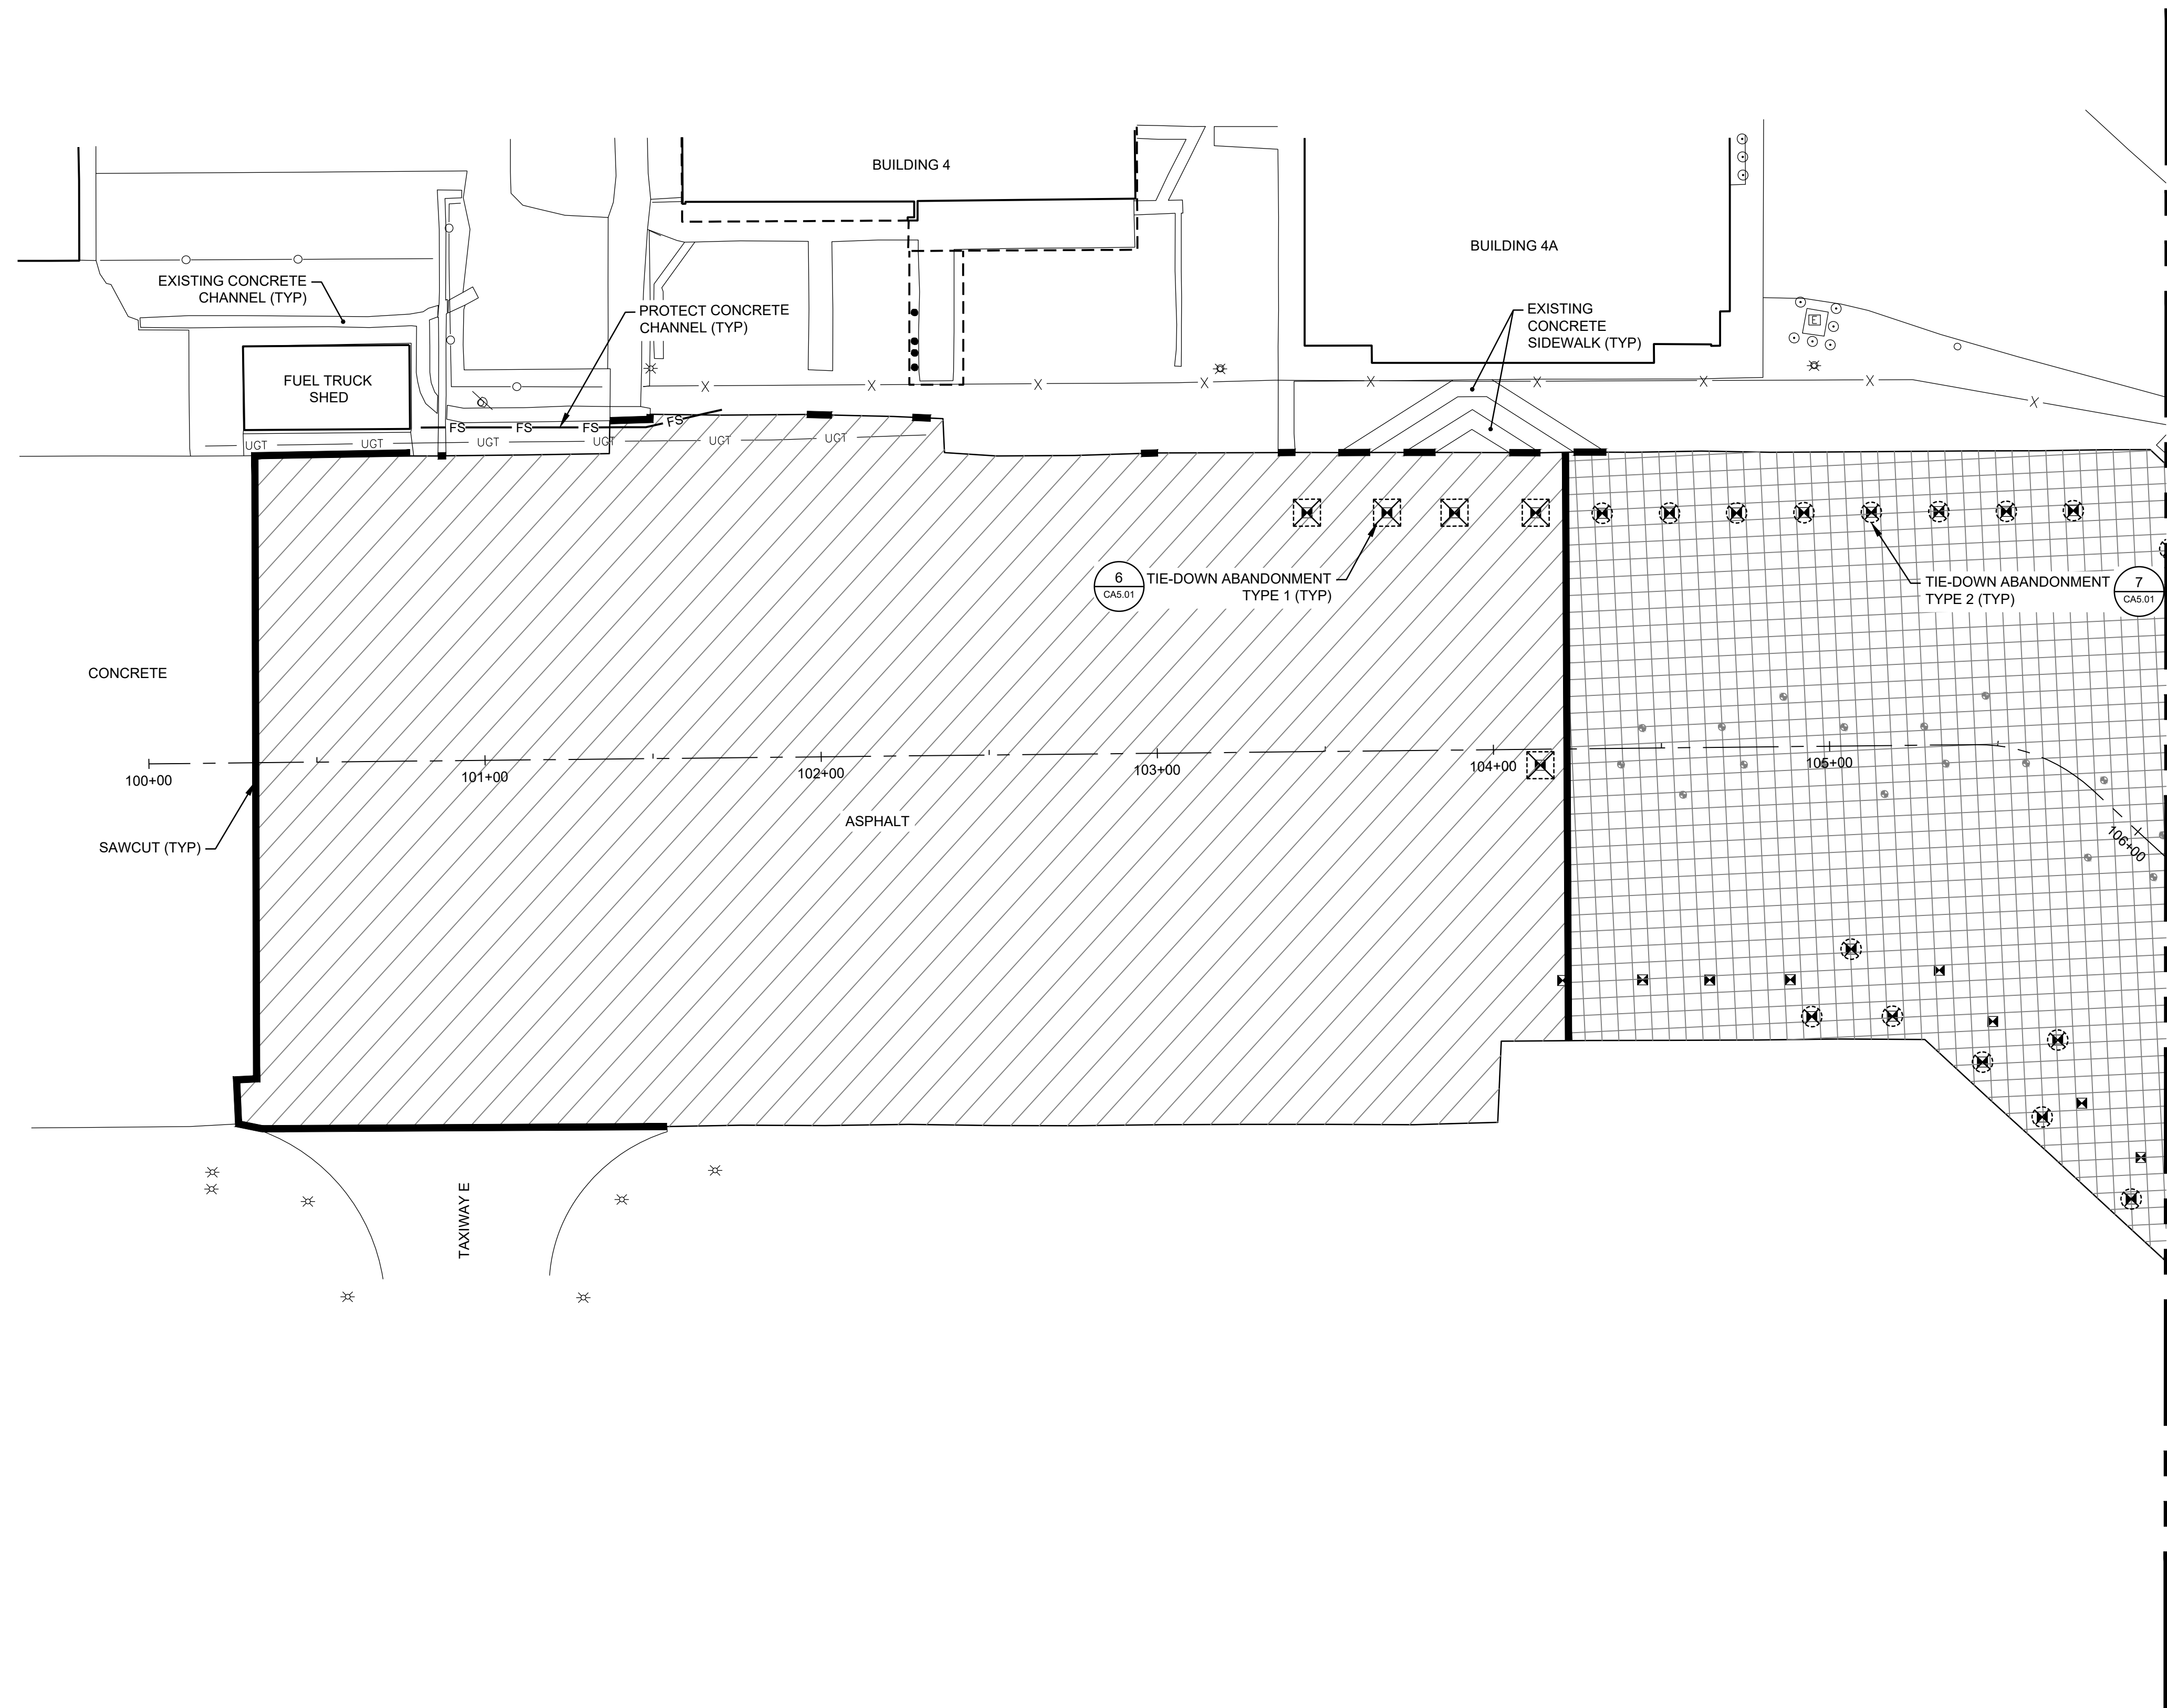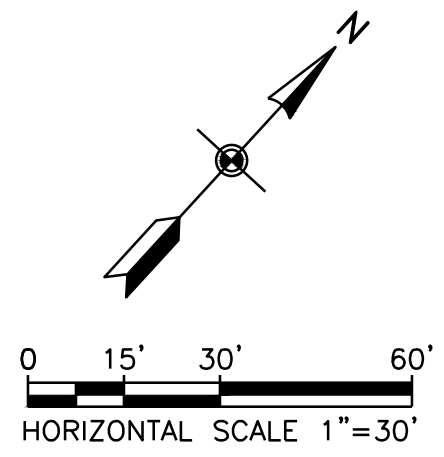

LEGEND

- 1.5" DEPTH MILL BITUMINOUS ASPHALT (ITEM P-101-5.2), JOINT AND CRACK REPAIR OF EXISTING CONCRETE (ITEM P-101-5.1)
- THERMOPLASTIC COAL TAR EMULSION SURFACE PREPARATION (ITEM P-629-8.1), JOINT AND CRACK REPAIR OF EXISTING CONCRETE (ITEM P-101-5.1)
- SAWCUT (INCIDENTAL TO ITEM P-101-5.2)
- TIE-DOWN ABANDONMENT TYPE 1 (ITEM P-101-5.3)
- TIE-DOWN ABANDONMENT TYPE 2 (ITEM P-101-5.4)
- PROPOSED INLET PROTECTION (INCIDENTAL TO ITEM C-102-5.1)
- PROPOSED FILTER SOCK (INCIDENTAL TO ITEM C-102-5.1)
- EXISTING PERIMETER FENCE
- EXISTING EDGE OF PAVEMENT
- EXISTING TIEDOWN ANCHOR

NOTES:

1. SAWCUT ALONG THE PERIMETER OF MILLED AREA. SAWCUT DEPTH TO EQUAL MILLED DEPTH.

METROPOLITAN TOPEKA AIRPORT AUTHORITY

**PHILIP BILLARD MUNICIPAL AIRPORT
 TERMINAL APRON REHABILITATION**

AIP CONSTRUCTION GRANT NO. 3-20-0082-027
 BIL-AIG CONSTRUCTION GRANT NO. 3-20-0082-028

NO.	DATE	BY	DESCRIPTION

ISSUED FOR BID


SHEET TITLE
**DEMOLITION PLAN
 SHEET 2 OF 3**

DATE **FEBRUARY 14, 2025**
 SCALE **1" = 30'**
 DRAWN BY **BF**
 CHECKED BY **LDS**
 APPROVED BY **SFS**

WSP PROJECT NUMBER **US0040451.4453**

SHEET NUMBER **CD1.02**

SHEET **12 OF 22**

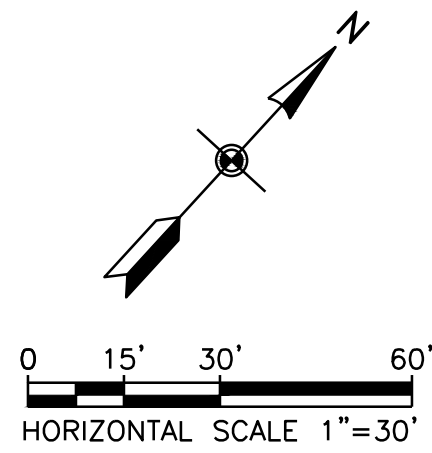


LEGEND

- 3" DEPTH MILL BITUMINOUS ASPHALT (ITEM P-101-5.2). JOINT AND CRACK REPAIR OF EXISTING CONCRETE (ITEM P-101-5.1)
- THERMOPLASTIC COAL TAR EMULSION SURFACE PREPARATION (ITEM P-629-8.1). JOINT AND CRACK REPAIR OF EXISTING CONCRETE (ITEM P-101-5.1)
- SAWCUT (INCIDENTAL TO ITEM P-101-5.2)
- TIE-DOWN ABANDONMENT TYPE 1 (ITEM P-101-5.3)
- TIE-DOWN ABANDONMENT TYPE 2 (ITEM P-101-5.4)
- PROPOSED INLET PROTECTION (COST INCLUDED IN ITEM C-102-5.1)
- FS PROPOSED FILTER SOCK (COST INCLUDED IN ITEM C-102-5.1)
- EXISTING PERIMETER FENCE
- EXISTING EDGE OF PAVEMENT
- EXISTING TIEDOWN ANCHOR

NOTES:

1. SAWCUT ALONG THE PERIMETER OF MILLED AREA. SAWCUT DEPTH TO EQUAL MILLED DEPTH.

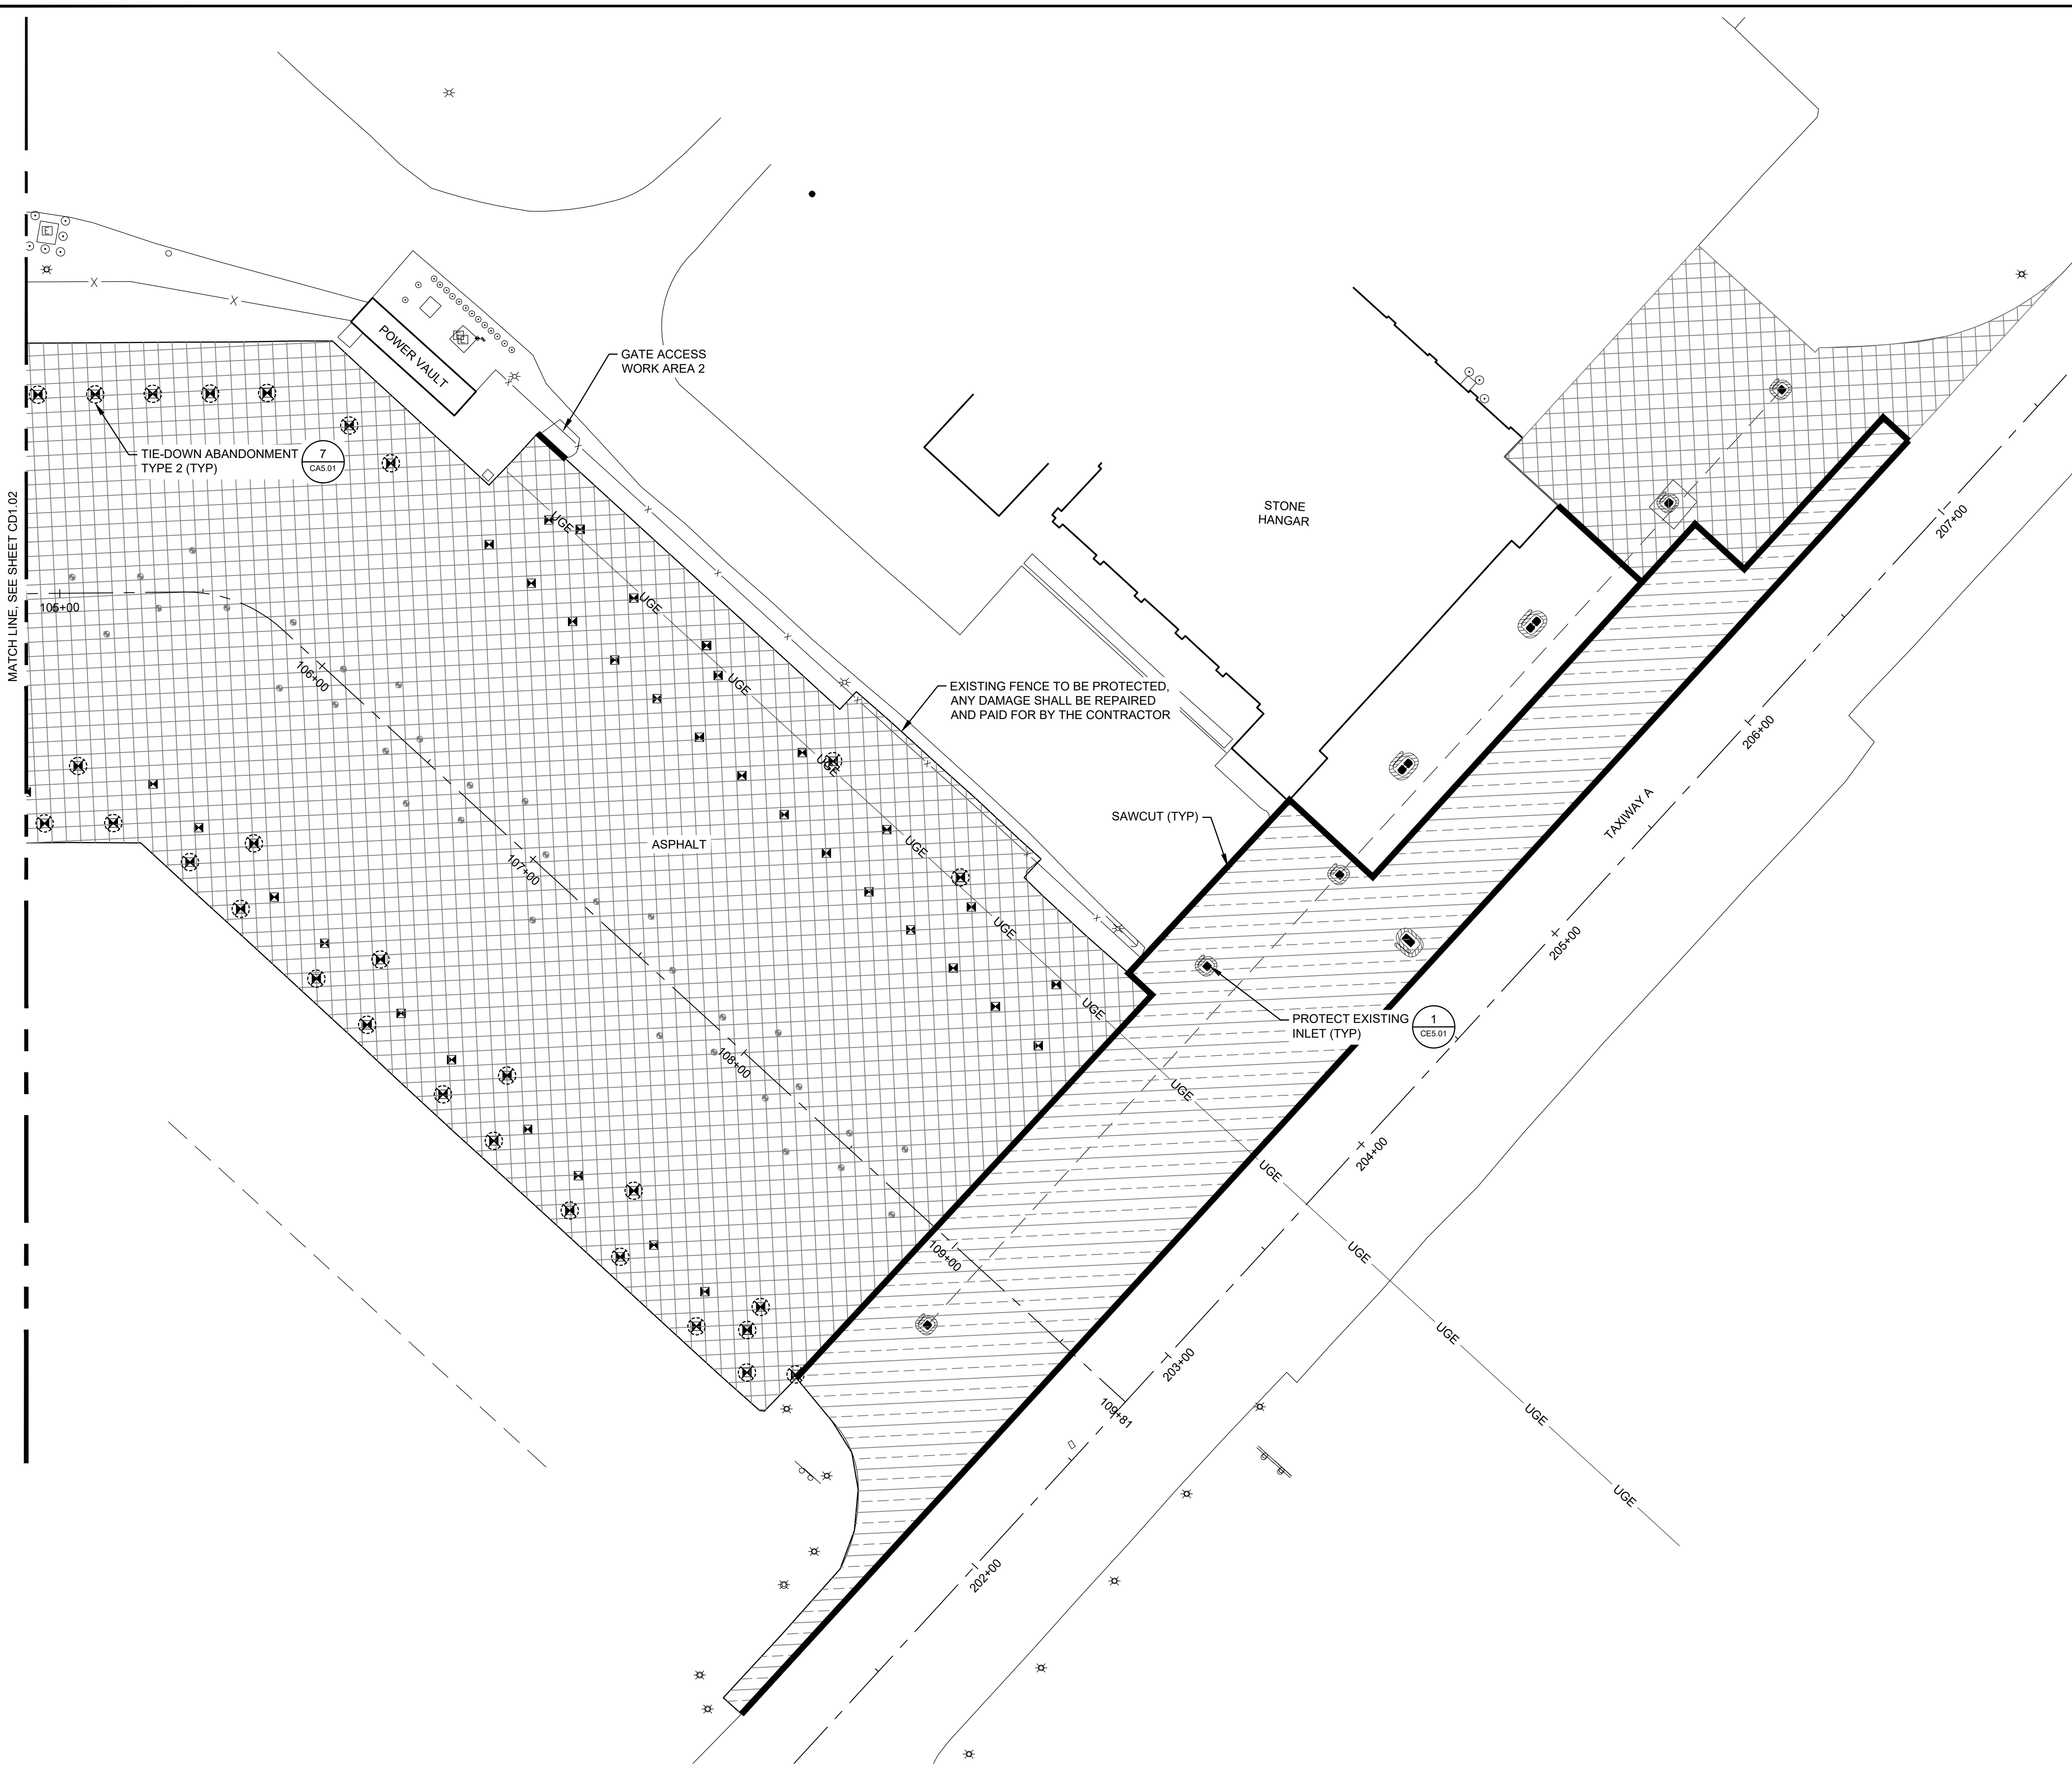

METROPOLITAN TOPEKA AIRPORT AUTHORITY



**PHILIP BILLARD MUNICIPAL AIRPORT
 TERMINAL APRON REHABILITATION**

AIP CONSTRUCTION GRANT NO. 3-20-0082-027
 BIL-AIG CONSTRUCTION GRANT NO. 3-20-0082-028

NO.	DATE	BY	DESCRIPTION


ISSUED FOR BID

SHEET TITLE	
DEMOLITION PLAN SHEET 3 OF 3	
DATE	FEBRUARY 14, 2025
SCALE	1" = 30'
DRAWN BY	BF
CHECKED BY	LDS
APPROVED BY	SFS
WSP PROJECT NUMBER US0040451.4453	
SHEET NUMBER	CD1.03
SHEET 13 OF 22	

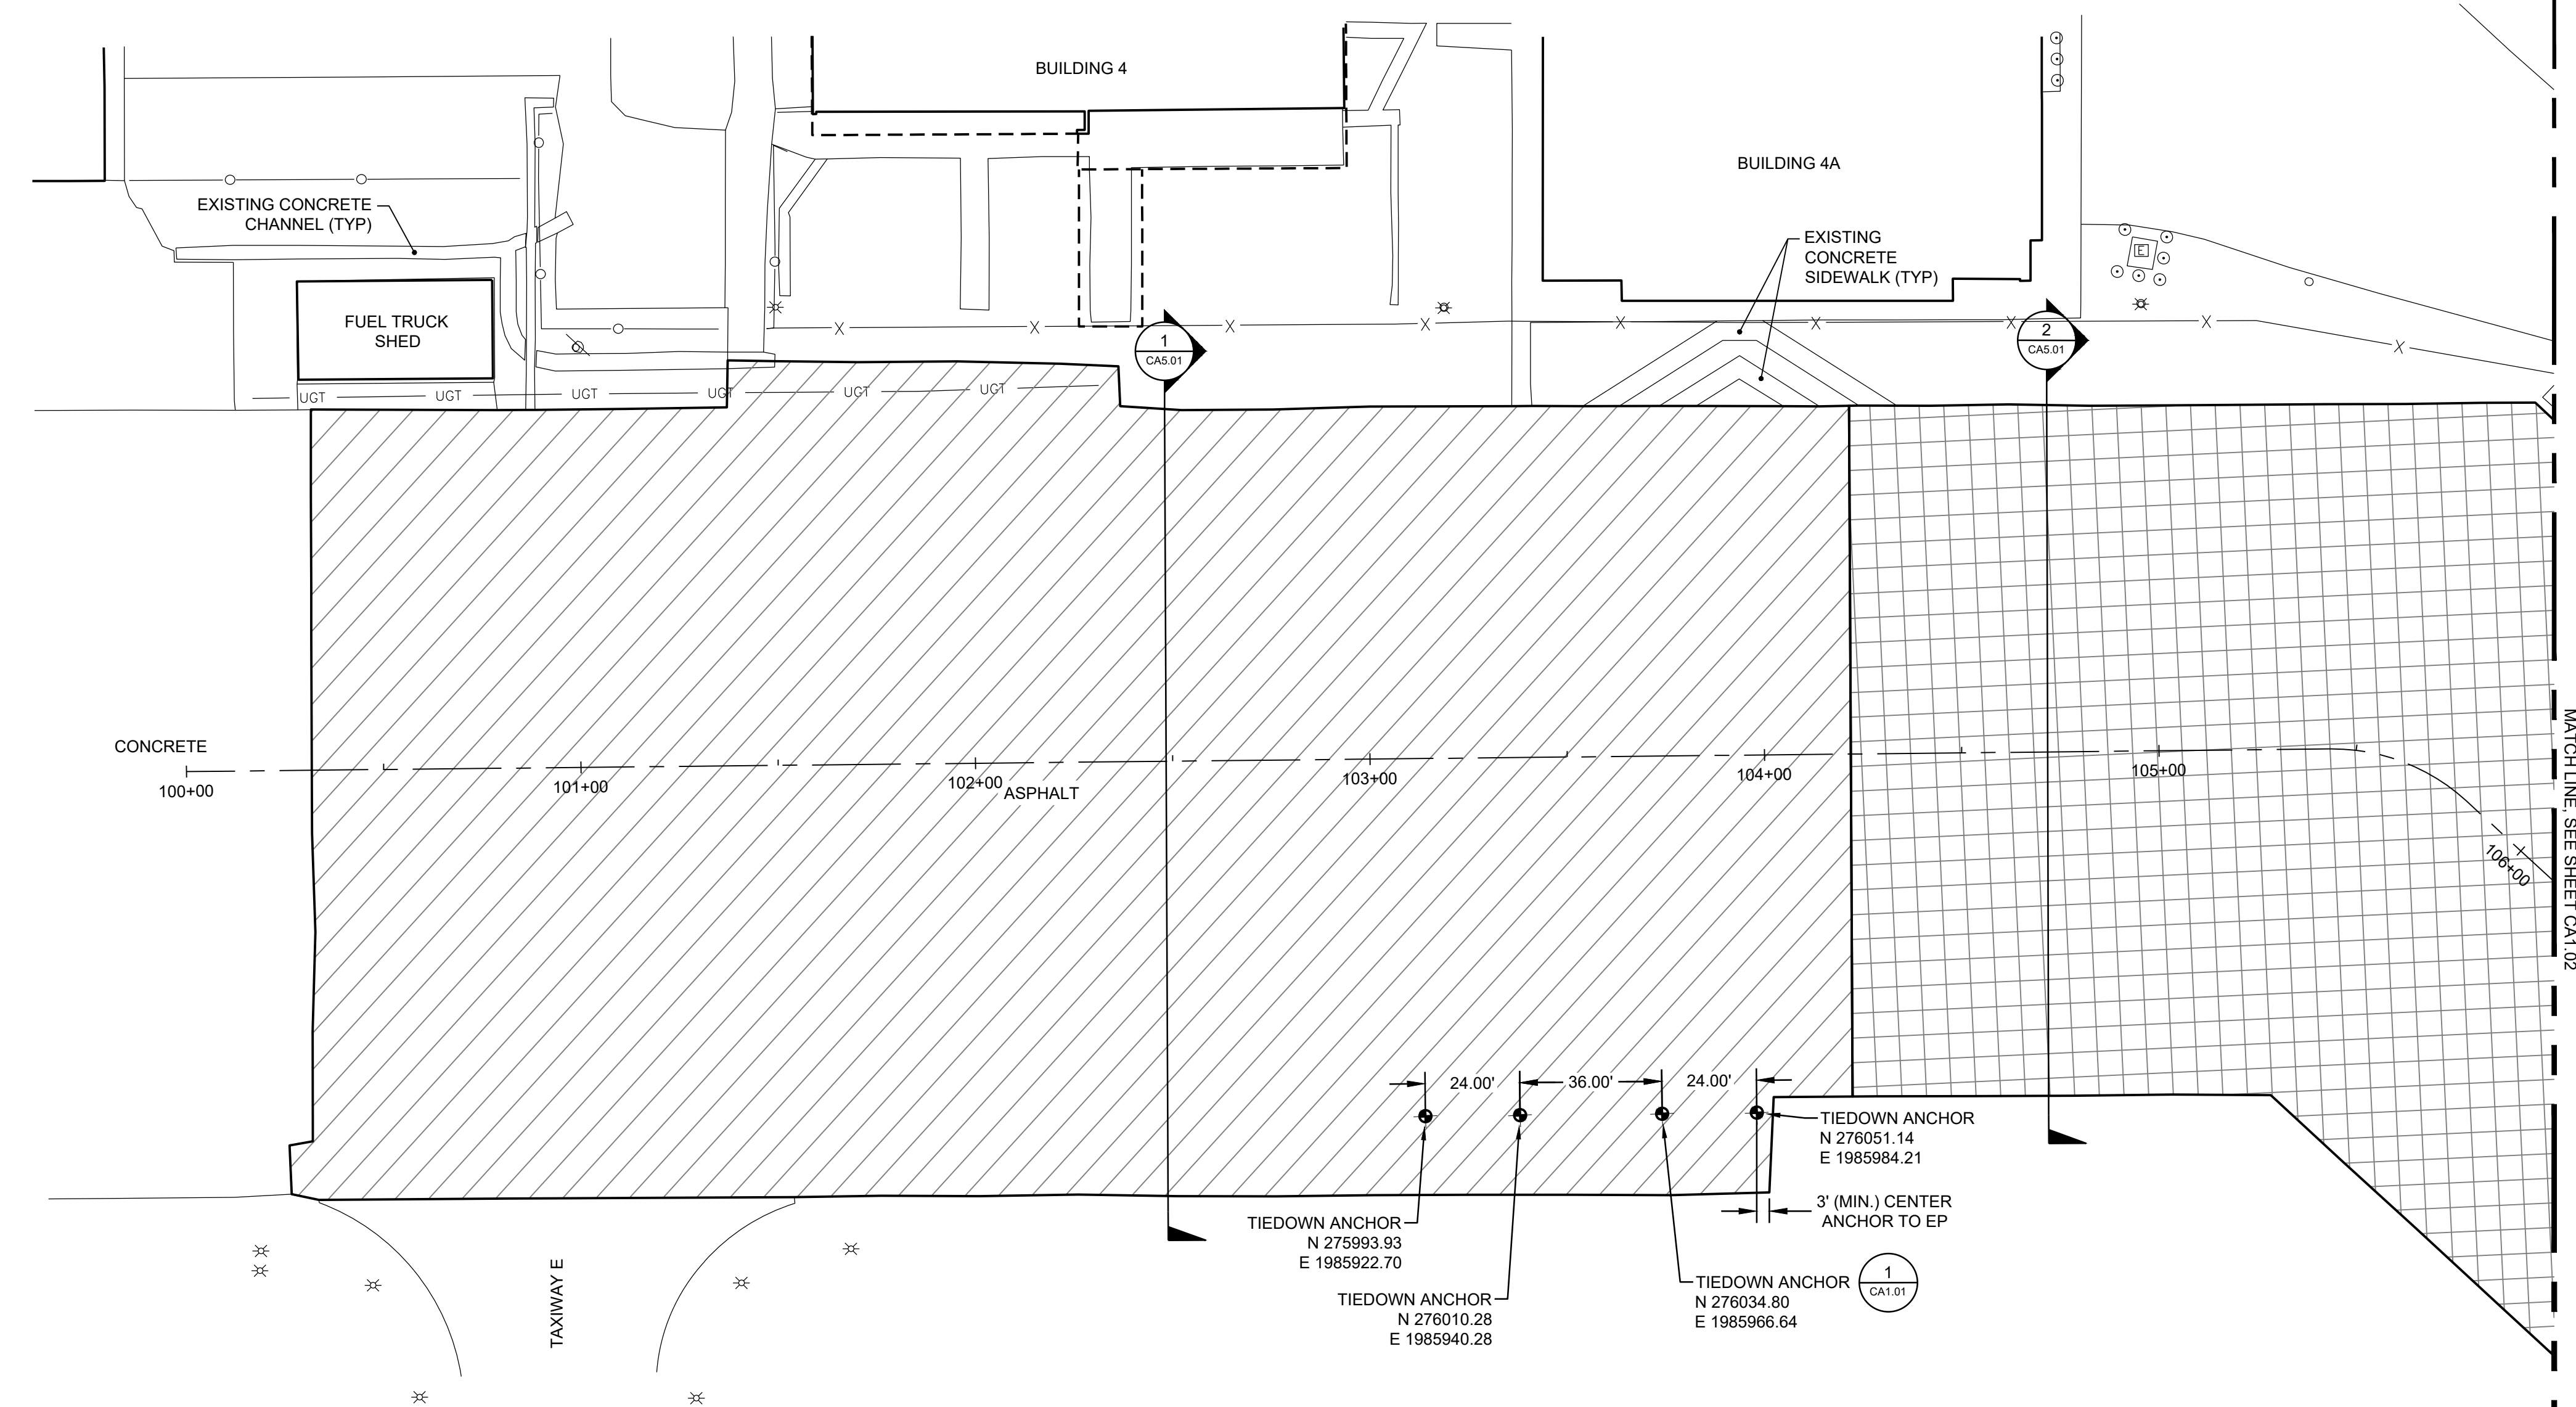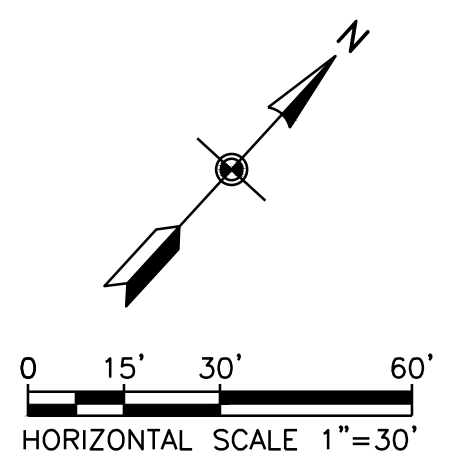

- LEGEND**
- 1.5" ASPHALT OVERLAY (ITEM P-401-8.2)
 - THERMOPLASTIC COAL TAR EMULSION APPLICATION (ITEM P-629-8.1)
 - PROPOSED TIE DOWN ANCHOR INSTALLATION (ITEM P-615-5.1)

- GENERAL NOTES:**
1. SEE DETAIL SHEET CA5.01 FOR PROPOSED TYPICAL PAVEMENT SECTIONS.
 2. THE CONTRACTOR MUST FIELD VERIFY EXISTING CONDITIONS PRIOR TO COMMENCEMENT OF CONSTRUCTION.

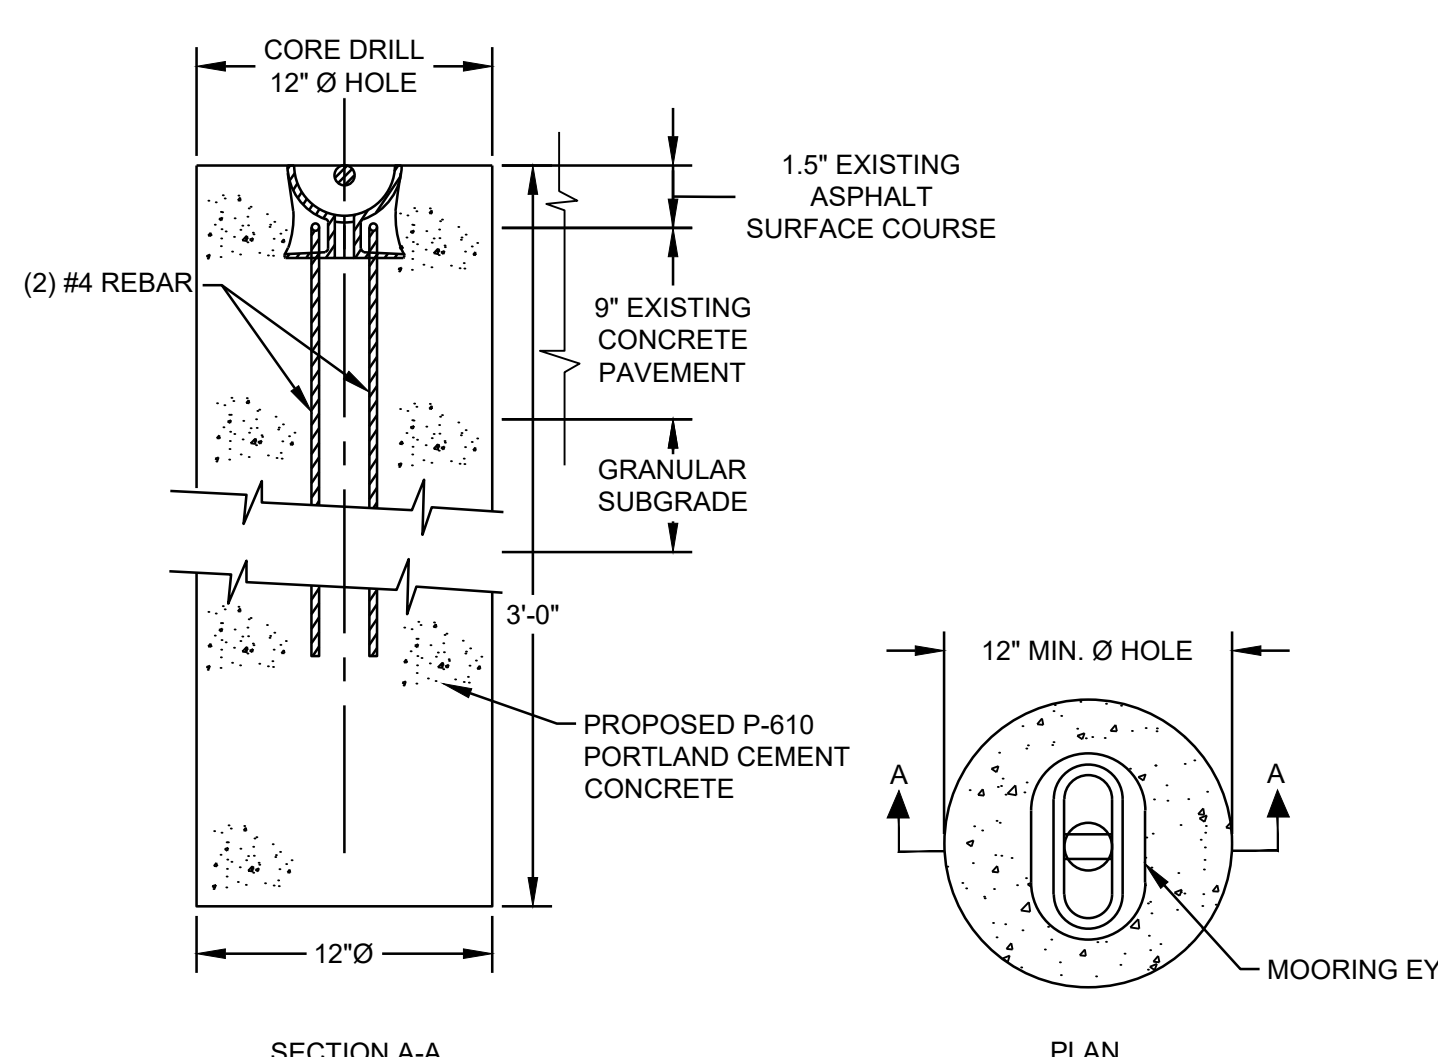

- NOTES:**
1. P-610 CONCRETE IS INCIDENTAL TO BID ITEM P-615-5.1 AIRCRAFT TIEDOWN
 2. NEENAH R-3490-A MOORING EYE OR EQUAL INSTALL PER MANUFACTURERS RECOMMENDATION. INCLUDE (2) #4 REBAR IN RIB.

1 TIEDOWN ANCHOR DETAIL
 CA1.01 SCALE: NTS

METROPOLITAN TOPEKA AIRPORT AUTHORITY
PHILIP BILLARD MUNICIPAL AIRPORT
TERMINAL APRON REHABILITATION
 AIP CONSTRUCTION GRANT NO. 3-20-0082-027
 BIL-AIG CONSTRUCTION GRANT NO. 3-20-0082-028

NO.	DATE	BY	DESCRIPTION

ISSUED FOR BID

SHEET TITLE
PAVING PLAN
SHEET 1 OF 2



DATE **FEBRUARY 14, 2025**
 SCALE **1" = 30'**
 DRAWN BY **BF**
 CHECKED BY **LDS**
 APPROVED BY **SFS**

WSP PROJECT NUMBER **US0040451.4453**

SHEET NUMBER **CA1.01**

SHEET **14** OF **22**

FILE NAME: US0040451.4453-CA1.DWG
 PLOT DATE: Feb 14, 2025 - 3:11PM

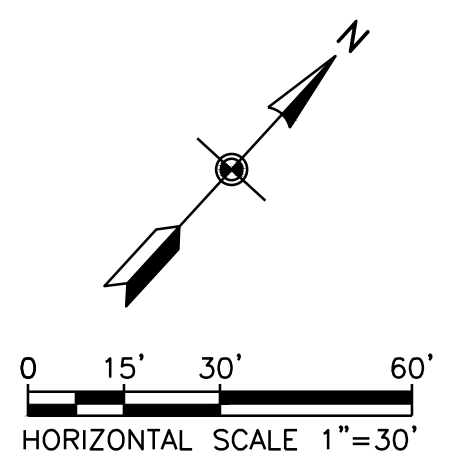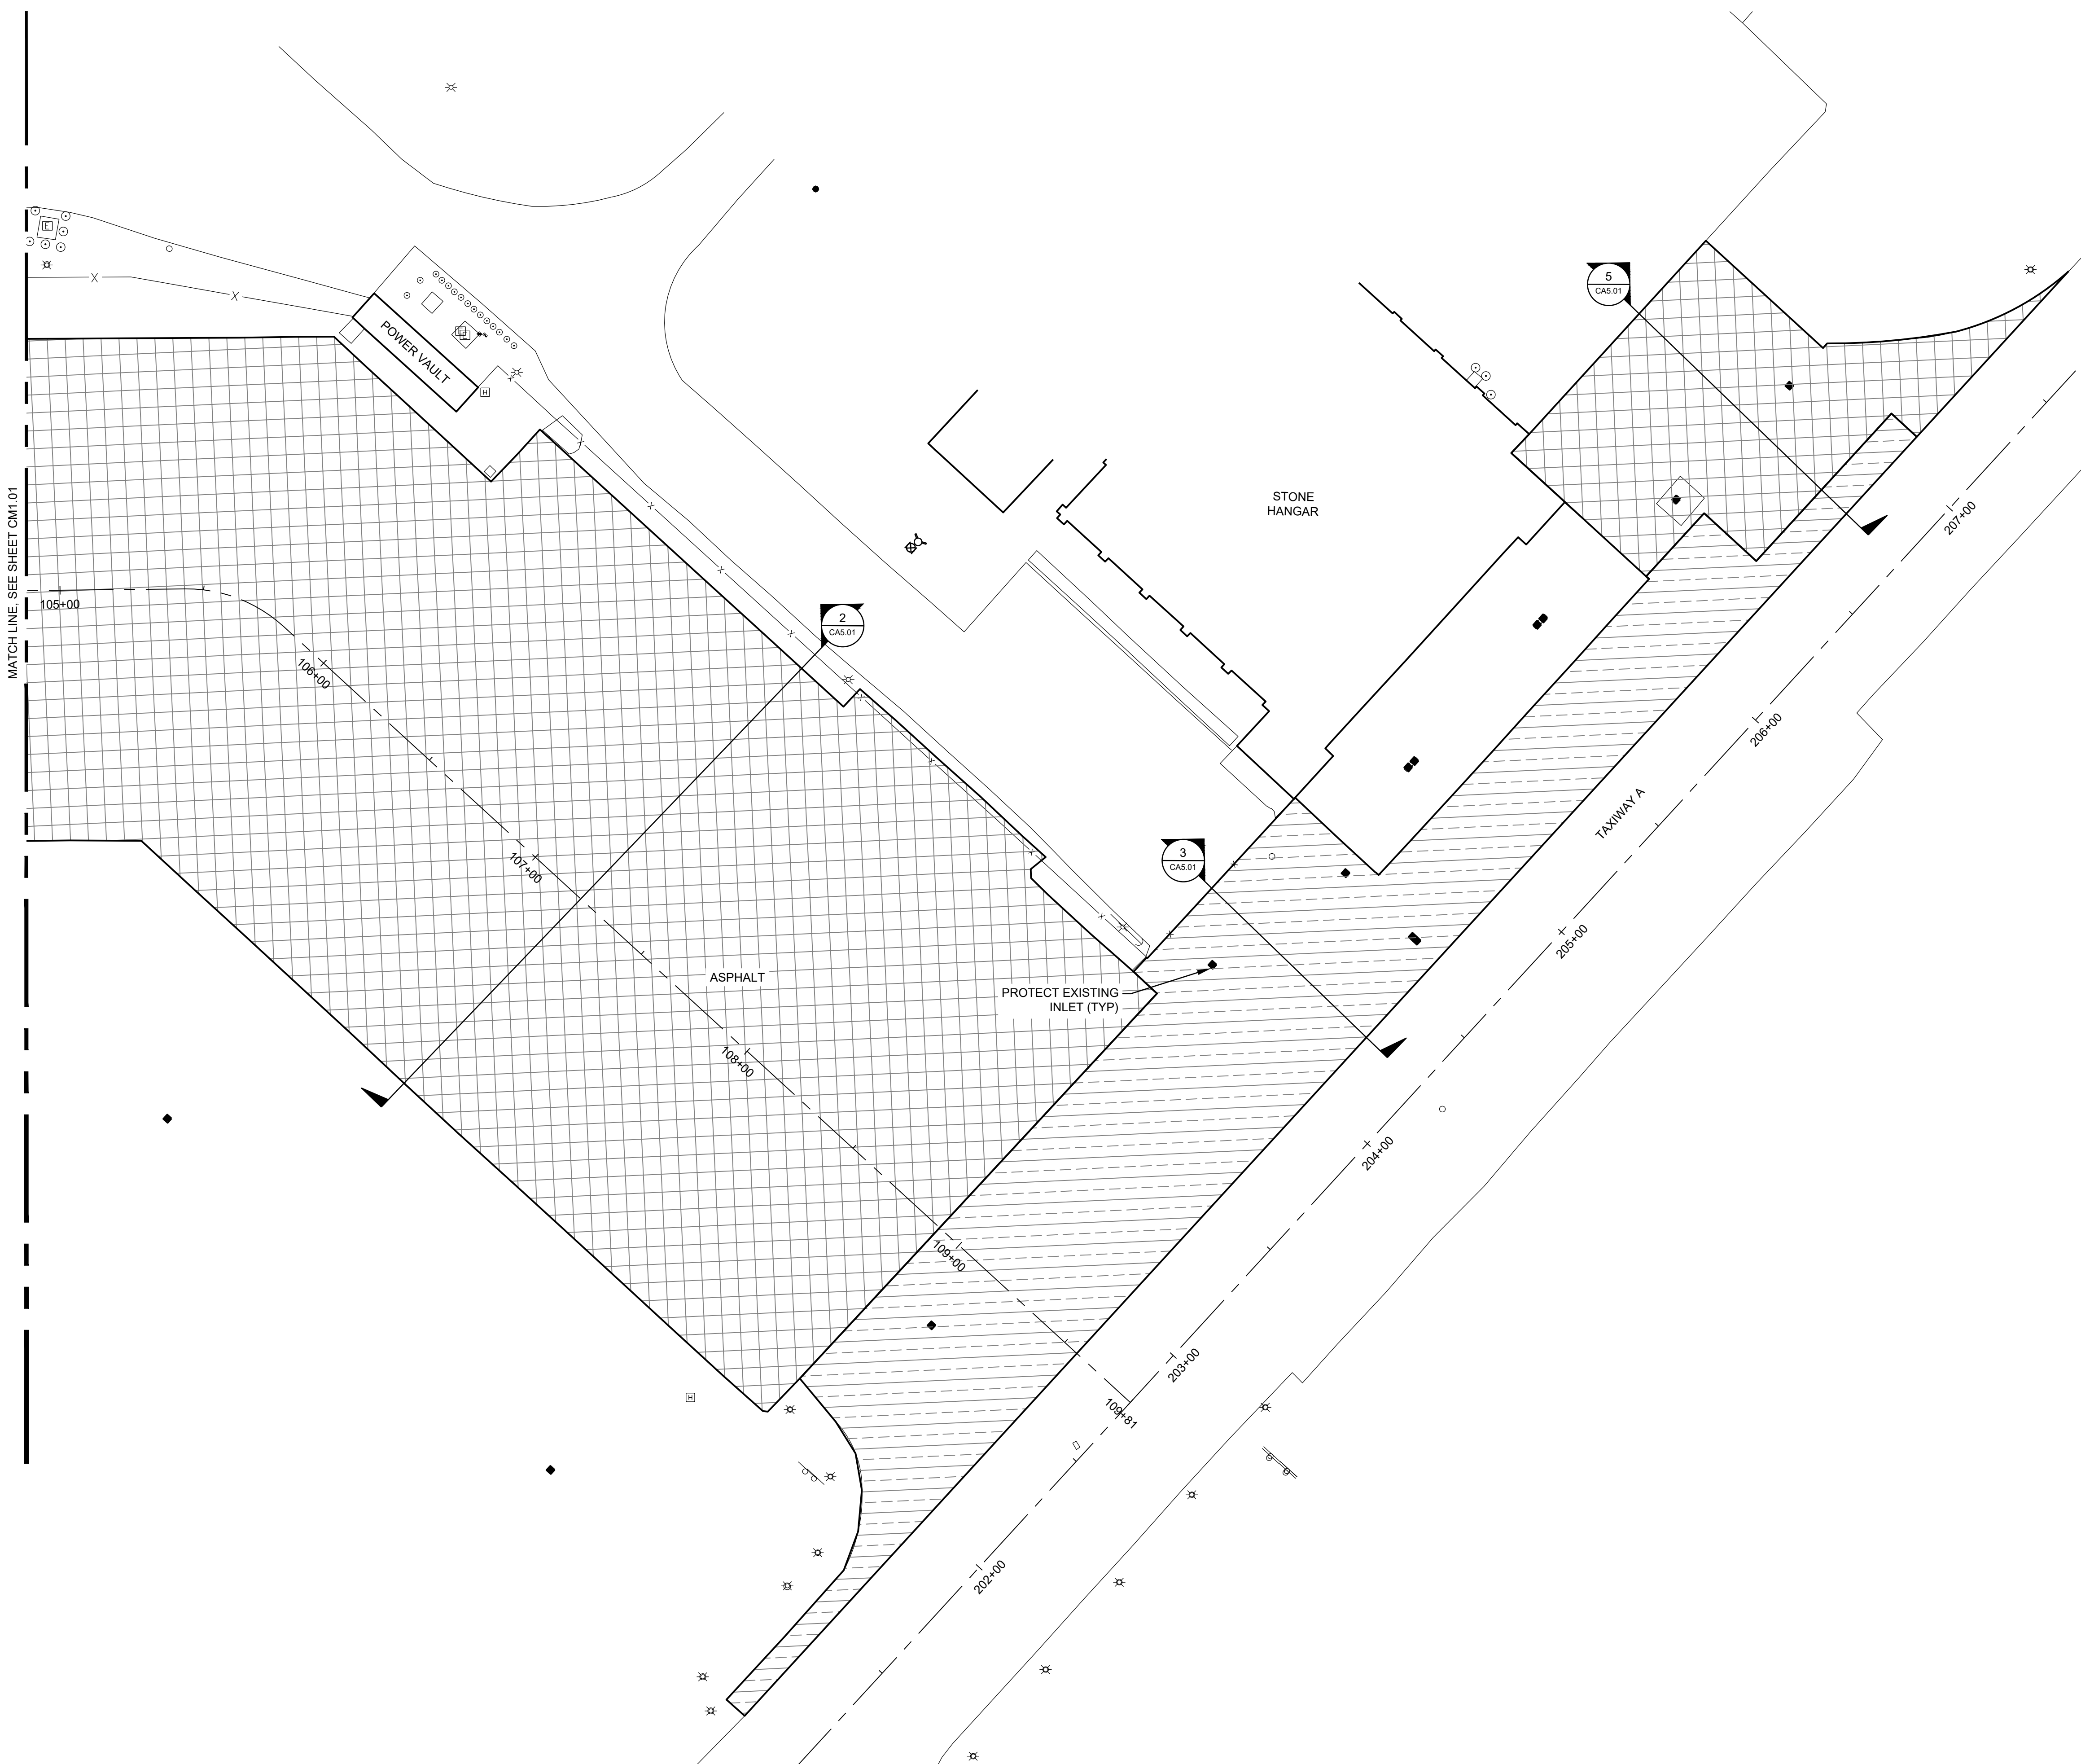

- LEGEND**
- 3" ASPHALT OVERLAY (2.25" 1ST LIFT, 0.75" 2ND LIFT) (ITEM P-401-8.2)
 - THERMOPLASTIC COAL TAR EMULSION APPLICATION (ITEM P-629-8.1)

- GENERAL NOTES:**
1. SEE DETAIL SHEET CA5.01 FOR PROPOSED TYPICAL PAVEMENT SECTIONS.
 2. THE CONTRACTOR MUST FIELD VERIFY EXISTING CONDITIONS PRIOR TO COMMENCEMENT OF CONSTRUCTION.

wsp
 WSP USA INC.
 KANSAS
 LICENSE NO. E-447
 300 WYANDOTTE STREET, SUITE 200
 KANSAS CITY, MO 64105
 T 816-702-4300 | www.wsp.com

MTAA
 METROPOLITAN TOPEKA AIRPORT AUTHORITY
 TOPEKA REGIONAL AIRPORT & BUSINESS CENTER | PHILIP BILLARD AIRPORT

METROPOLITAN TOPEKA AIRPORT AUTHORITY
PHILIP BILLARD MUNICIPAL AIRPORT
TERMINAL APRON REHABILITATION
 AIP CONSTRUCTION GRANT NO. 3-20-0082-027
 BIL-AIG CONSTRUCTION GRANT NO. 3-20-0082-028

NO.	DATE	BY	DESCRIPTION

ISSUED FOR BID

SHEET TITLE
PAVING PLAN
SHEET 2 OF 2

DATE **FEBRUARY 14, 2025**
 SCALE **1" = 30'**
 DRAWN BY **BF**
 CHECKED BY **LDS**
 APPROVED BY **SFS**

WSP PROJECT NUMBER **US0040451.4453**

SHEET NUMBER **CA1.02**


SHEET **15** OF **22**

SCALE (S) AS NOTED ON THIS SHEET ARE BASED ON A FULL SIZE 22 X 34 SHEET


METROPOLITAN TOPEKA AIRPORT AUTHORITY

**PHILIP BILLARD MUNICIPAL AIRPORT
 TERMINAL APRON REHABILITATION**


AIP CONSTRUCTION GRANT NO. 3-20-0082-027
 BIL-AIG CONSTRUCTION GRANT NO. 3-20-0082-028

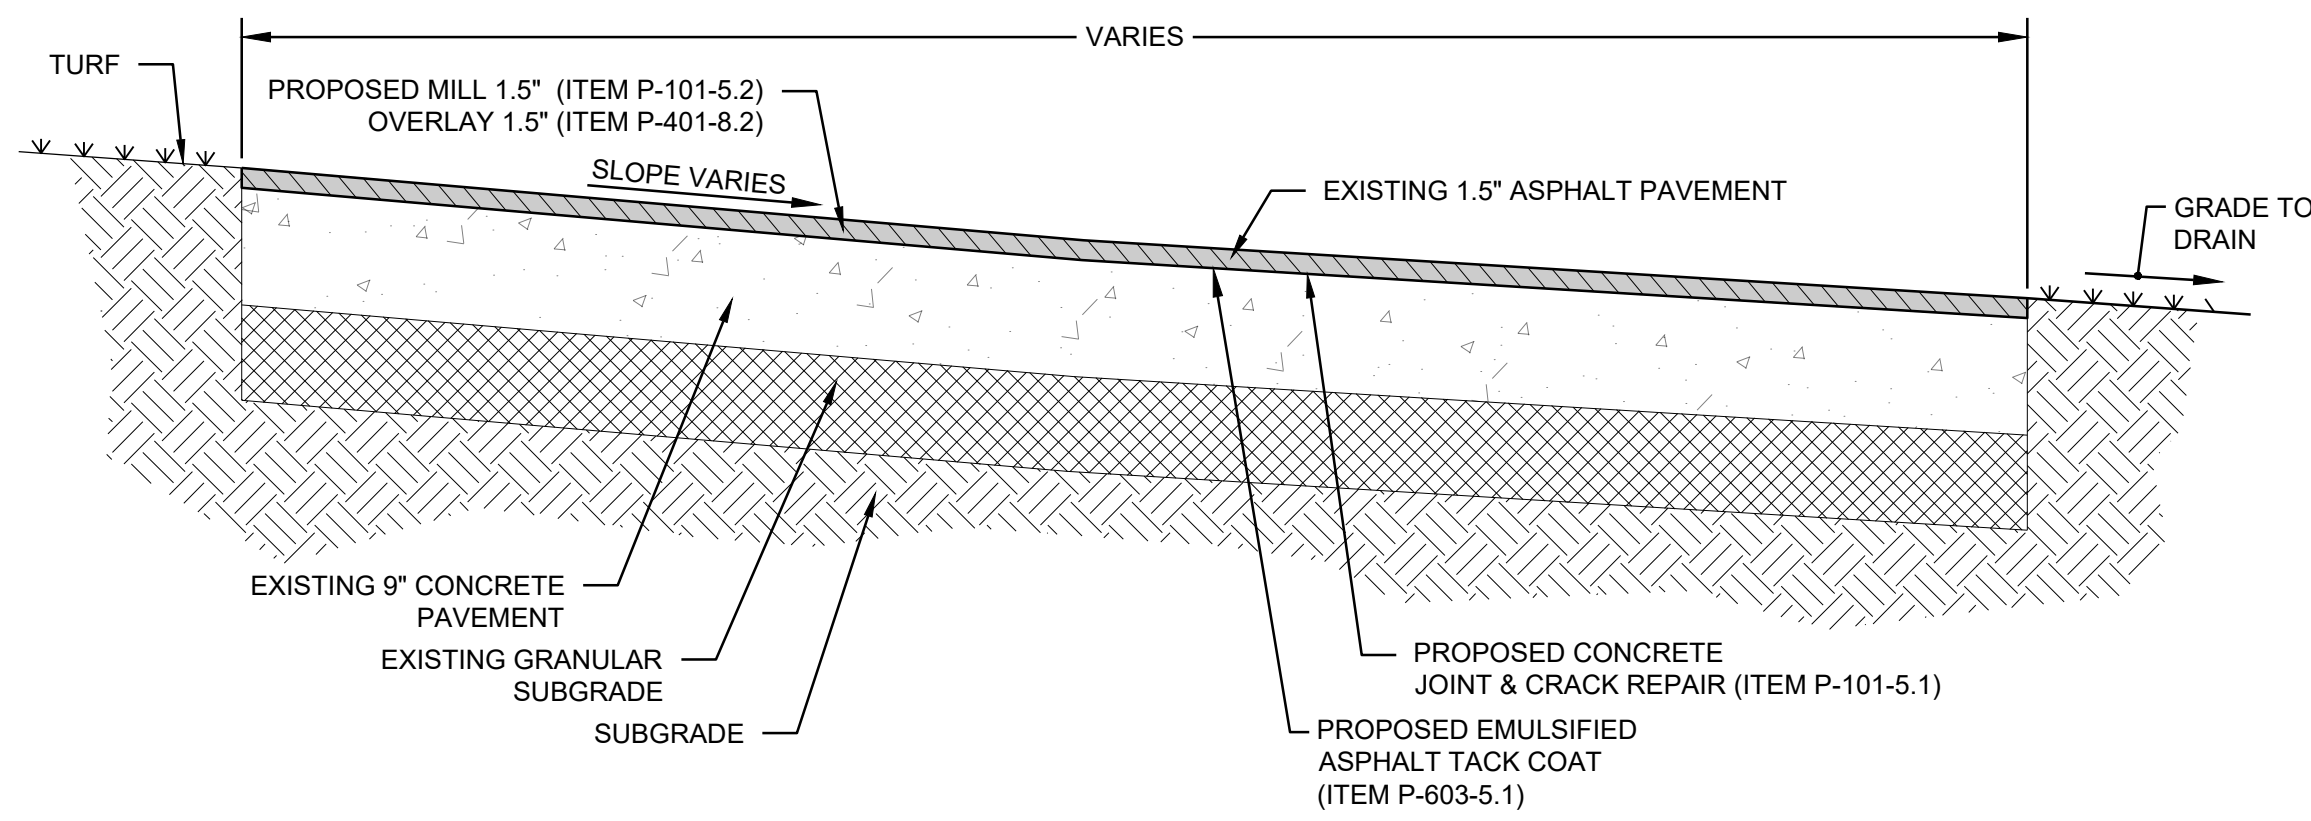


1 TYPICAL SECTION - TERMINAL APRON REHABILITATION
 CA5.01 SCALE: NTS STA 100+31.78 TO STA 104+21.89

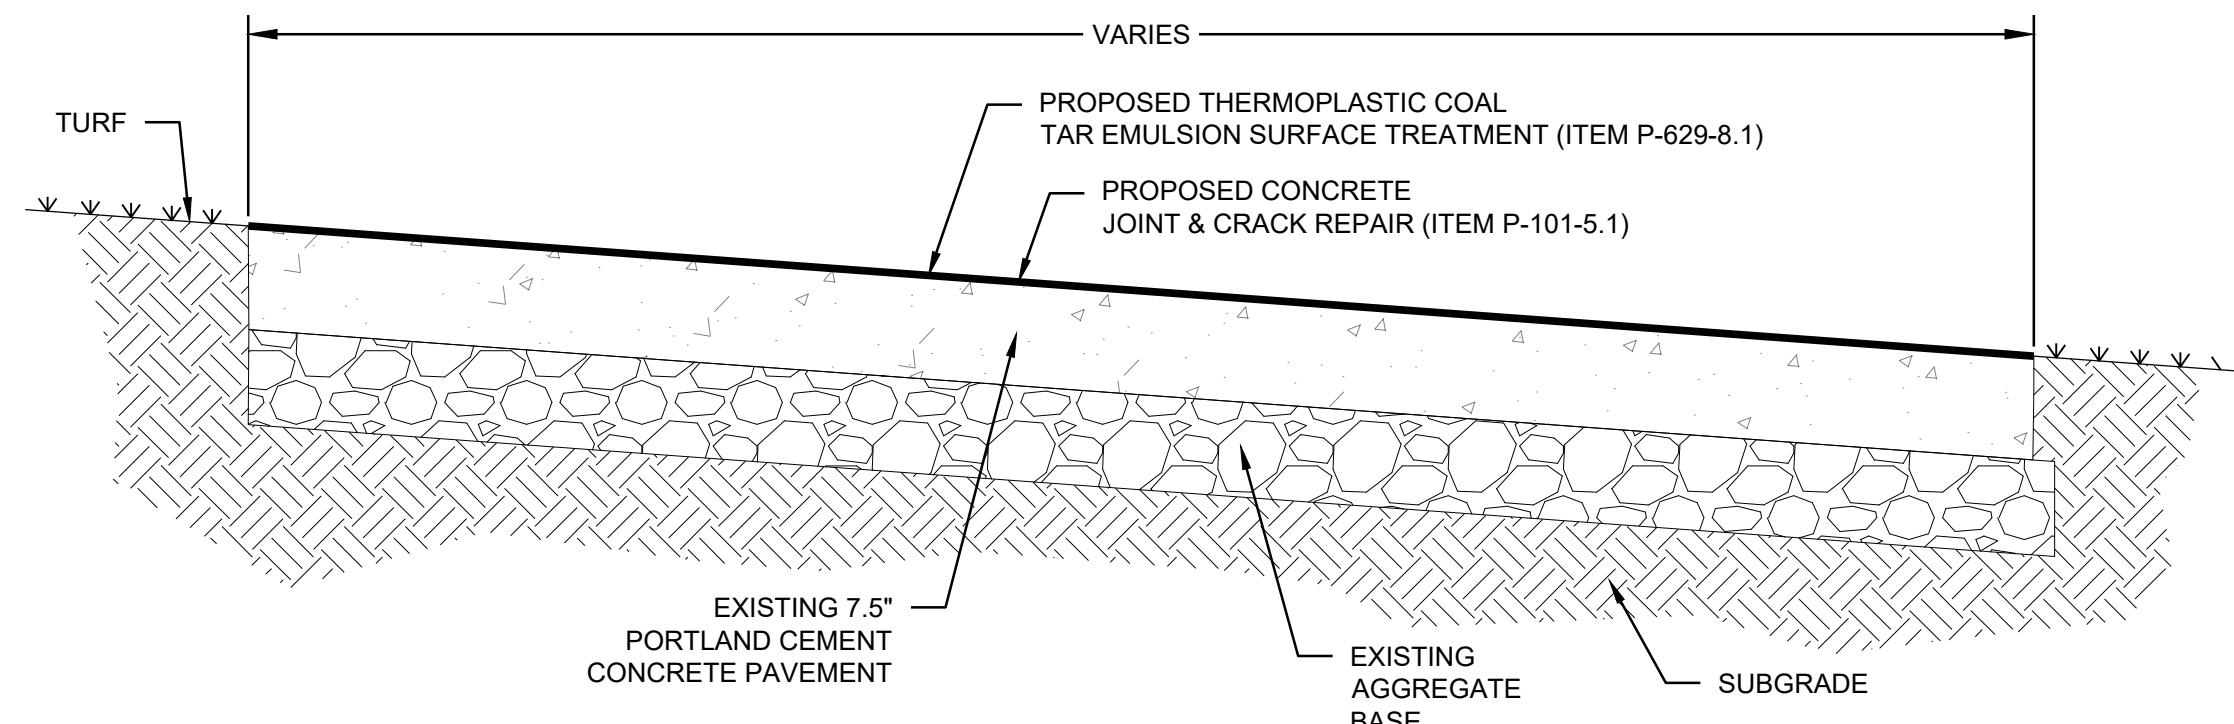


2 TYPICAL SECTION - SURFACE TREATMENT - APRON
 CA5.01 SCALE: NTS STA 104+21.89 TO STA 108+90.92

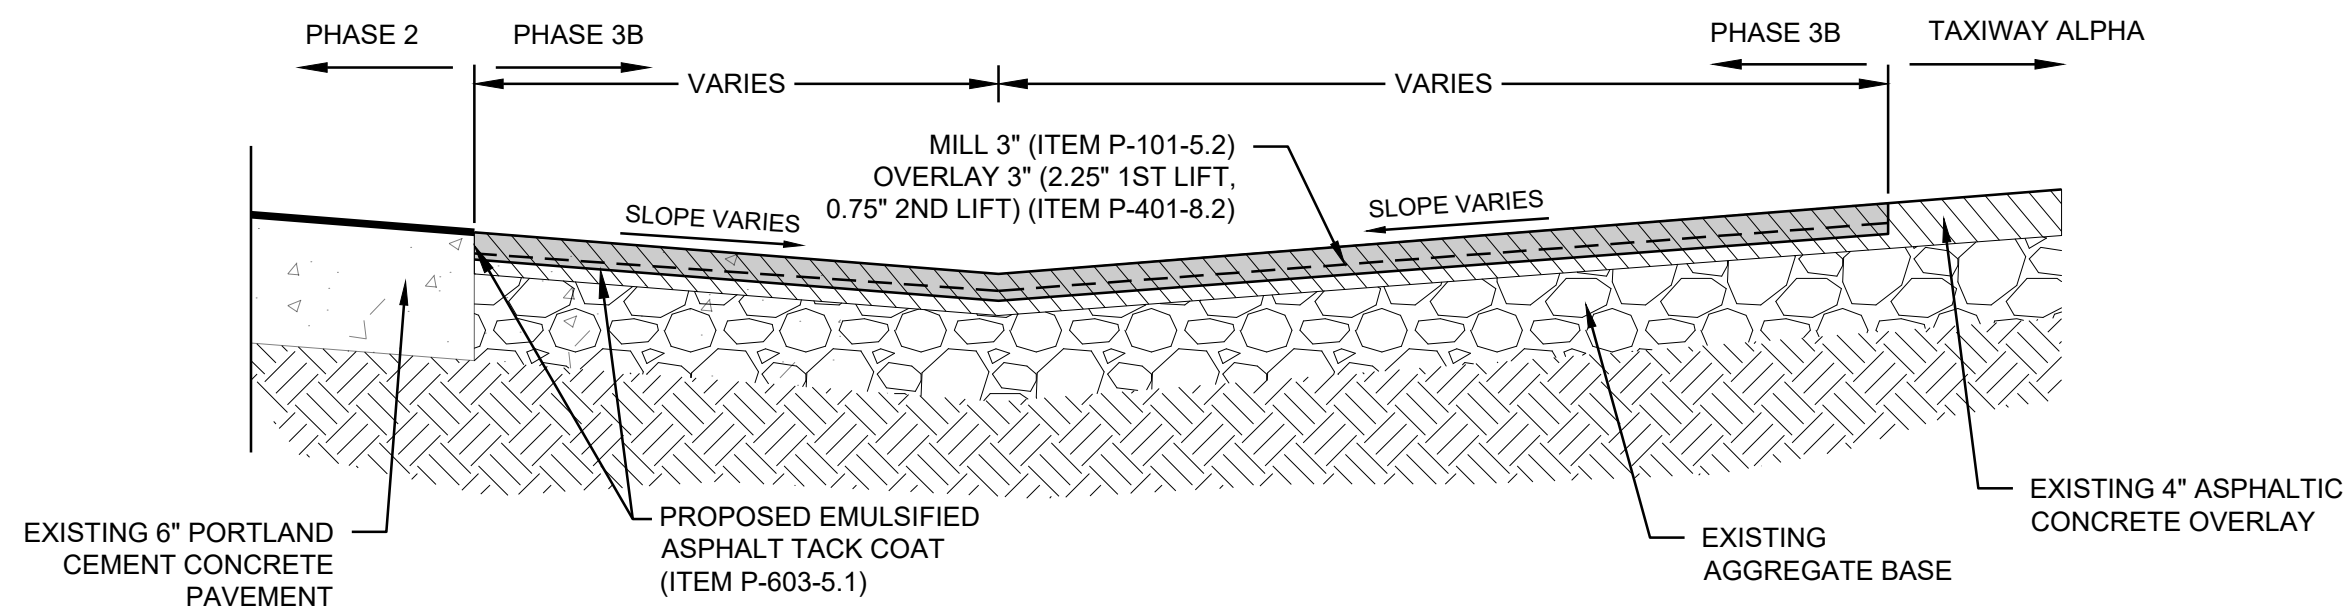


3 TYPICAL SECTION - PAVEMENT REHABILITATION - ADJACENT TO TWY ALPHA
 CA5.01 SCALE: NTS STA 202+06.25 TO 204+71.63

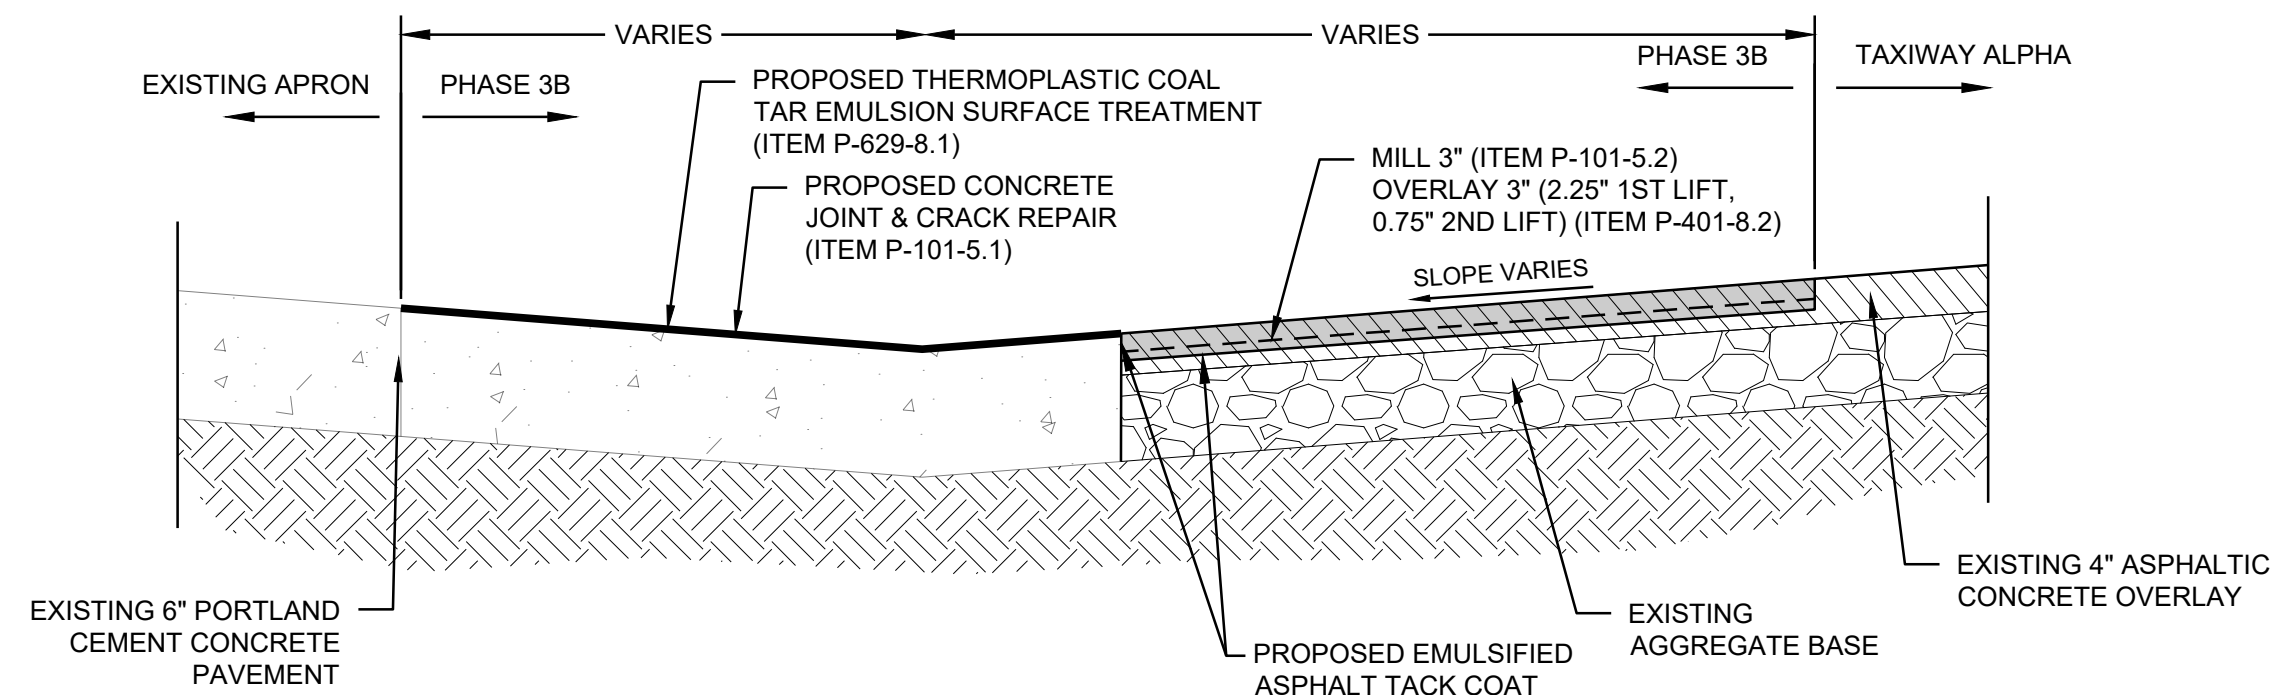

4 TYPICAL SECTION - PAVEMENT REHABILITATION - ADJACENT TO TWY ALPHA
 CA5.01 SCALE: NTS STA 204+71.63 TO STA 207+10.68

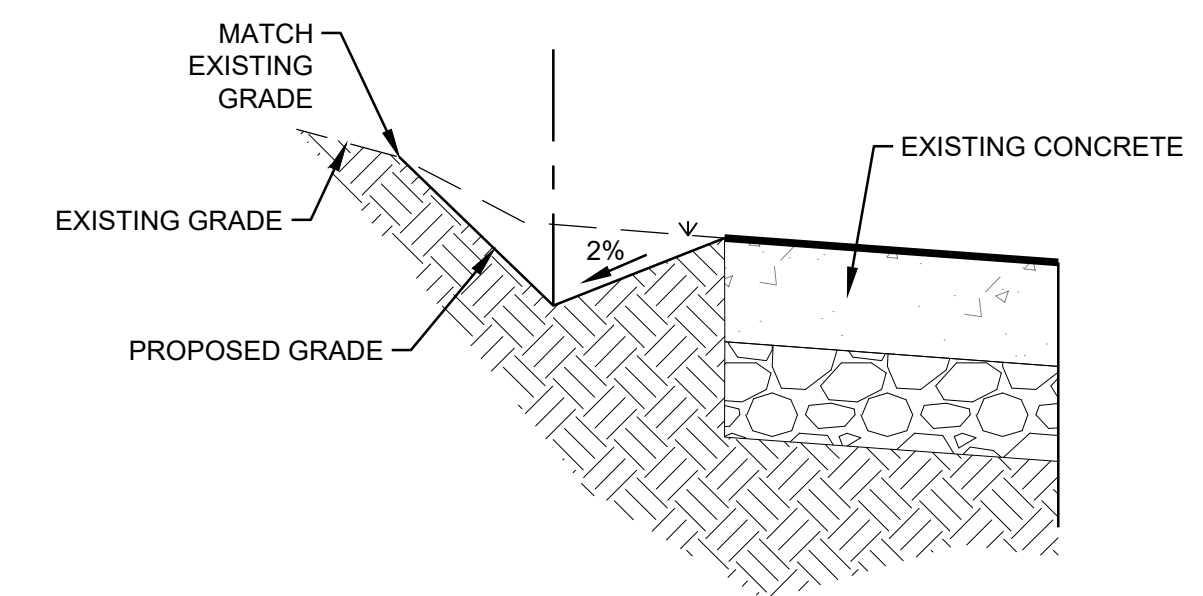


8 TYPICAL SECTION DITCH LINE
 CA5.01 SCALE: NTS

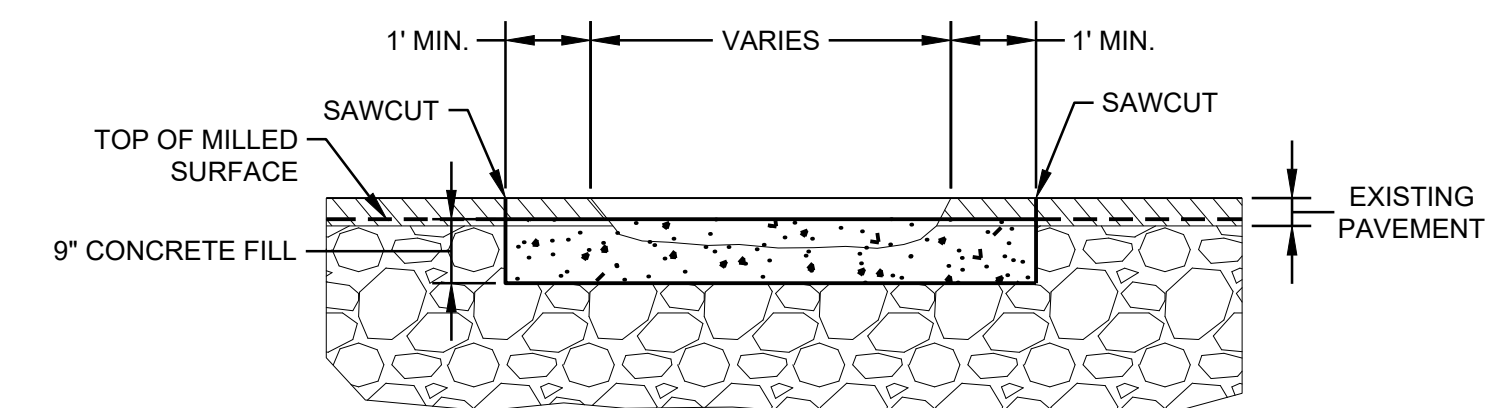


NOTE:
 CONSTRUCT ASPHALT PATCH TO MILLED SURFACE TO ALLOW FOR UNIFORM OVERLAY SECTION ABOVE PATCH. THE BID ITEM ASPHALT PAVEMENT PATCHING INCLUDES SAWCUT, EXCAVATION, 9\"/>


9 ASPHALT PAVEMENT PATCHING
 CA5.01 SCALE: NTS

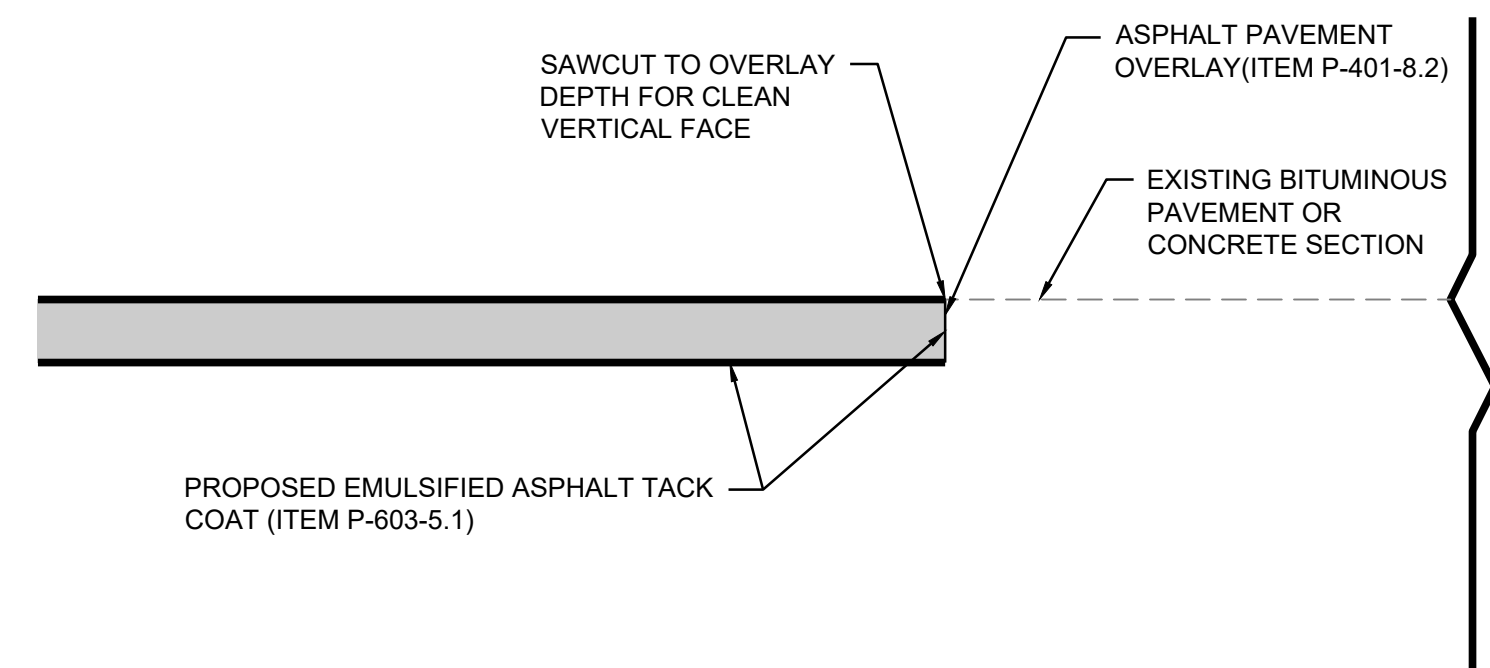

5 BITUMINOUS OVERLAY TO EXISTING BITUMINOUS PAVEMENT DETAIL
 CA5.01 SCALE: NTS

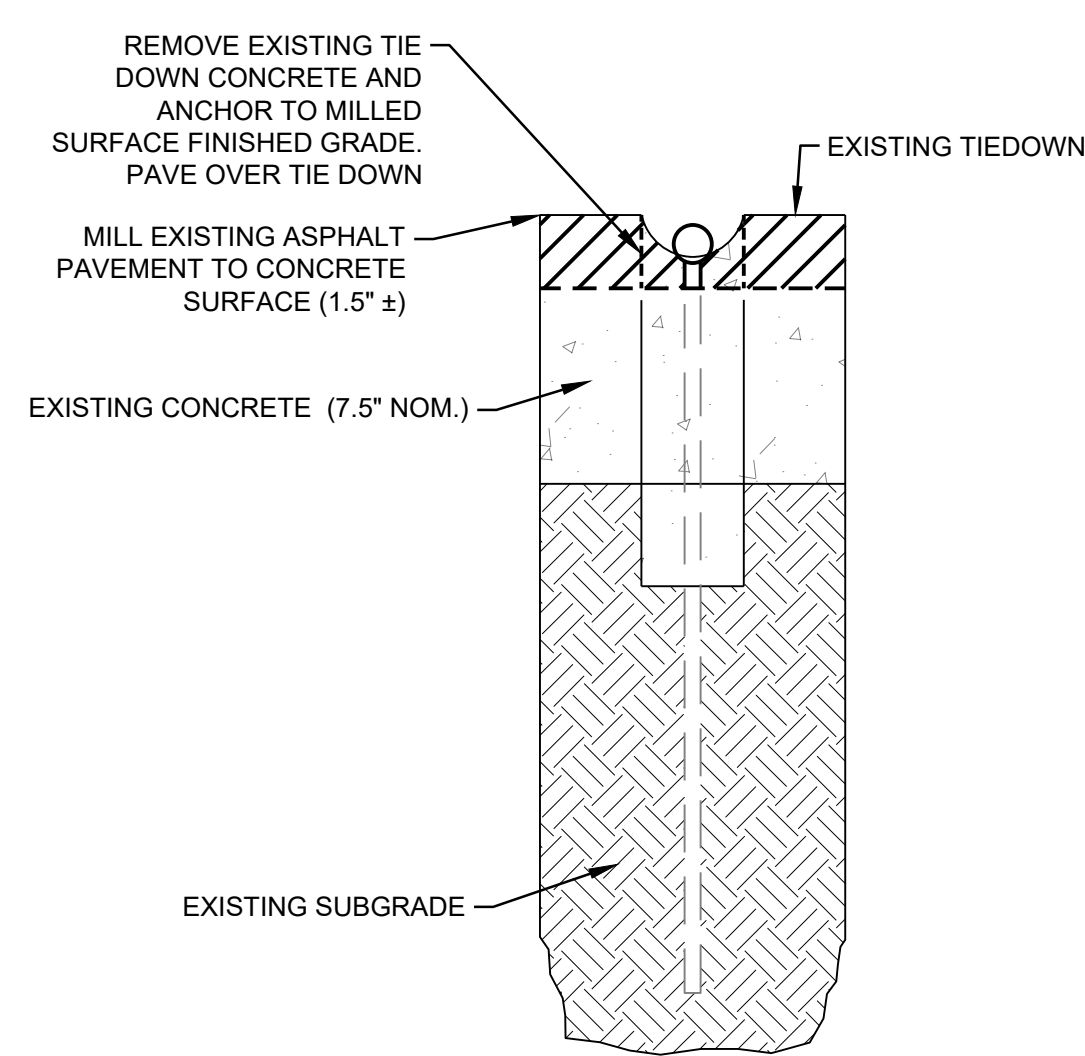

6 TIE-DOWN ABANDONMENT - TYPE 1 DETAIL
 CA5.01 SCALE: NTS

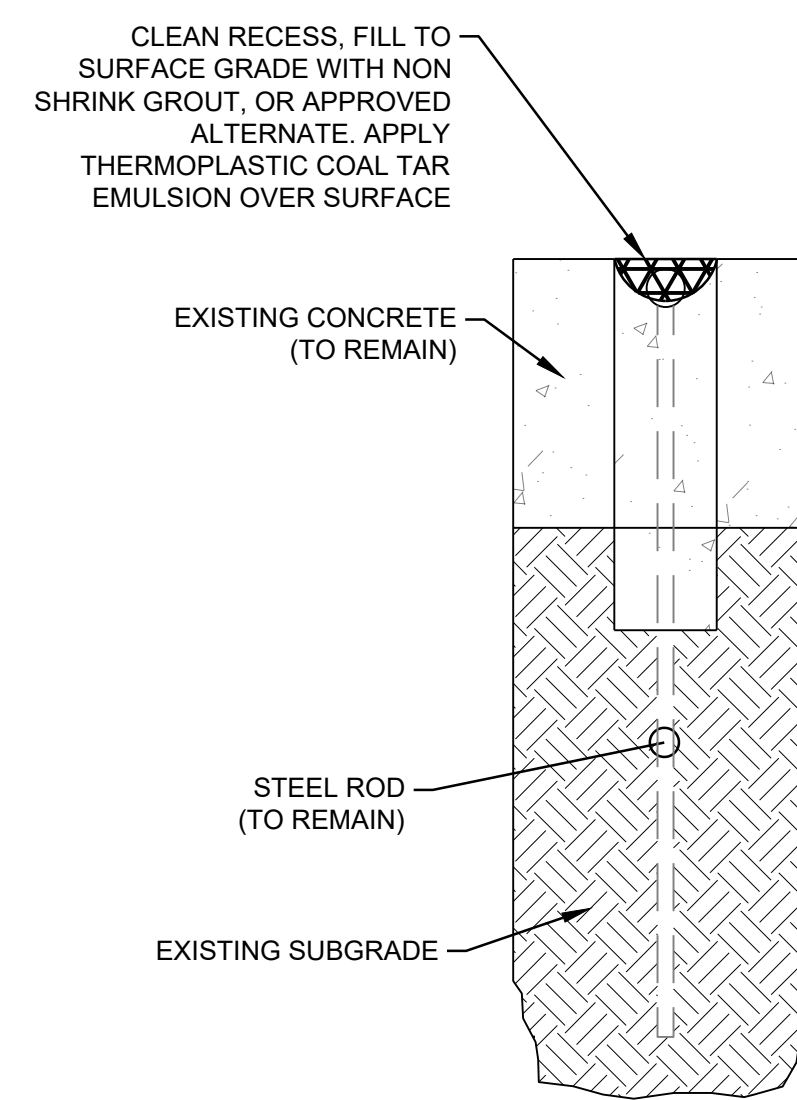

7 TIE-DOWN ABANDONMENT - TYPE 2 DETAIL
 CA5.01 SCALE: NTS

NO.	DATE	BY	DESCRIPTION

ISSUED FOR BID



SHEET TITLE
TYPICAL PAVEMENT SECTION

DATE **FEBRUARY 14, 2025**
 SCALE **NTS**
 DRAWN BY **BF**
 CHECKED BY **LDS**
 APPROVED BY **SFS**

WSP PROJECT NUMBER **US0040451.4453**

SHEET NUMBER **CA5.01**

SHEET **16 OF 22**

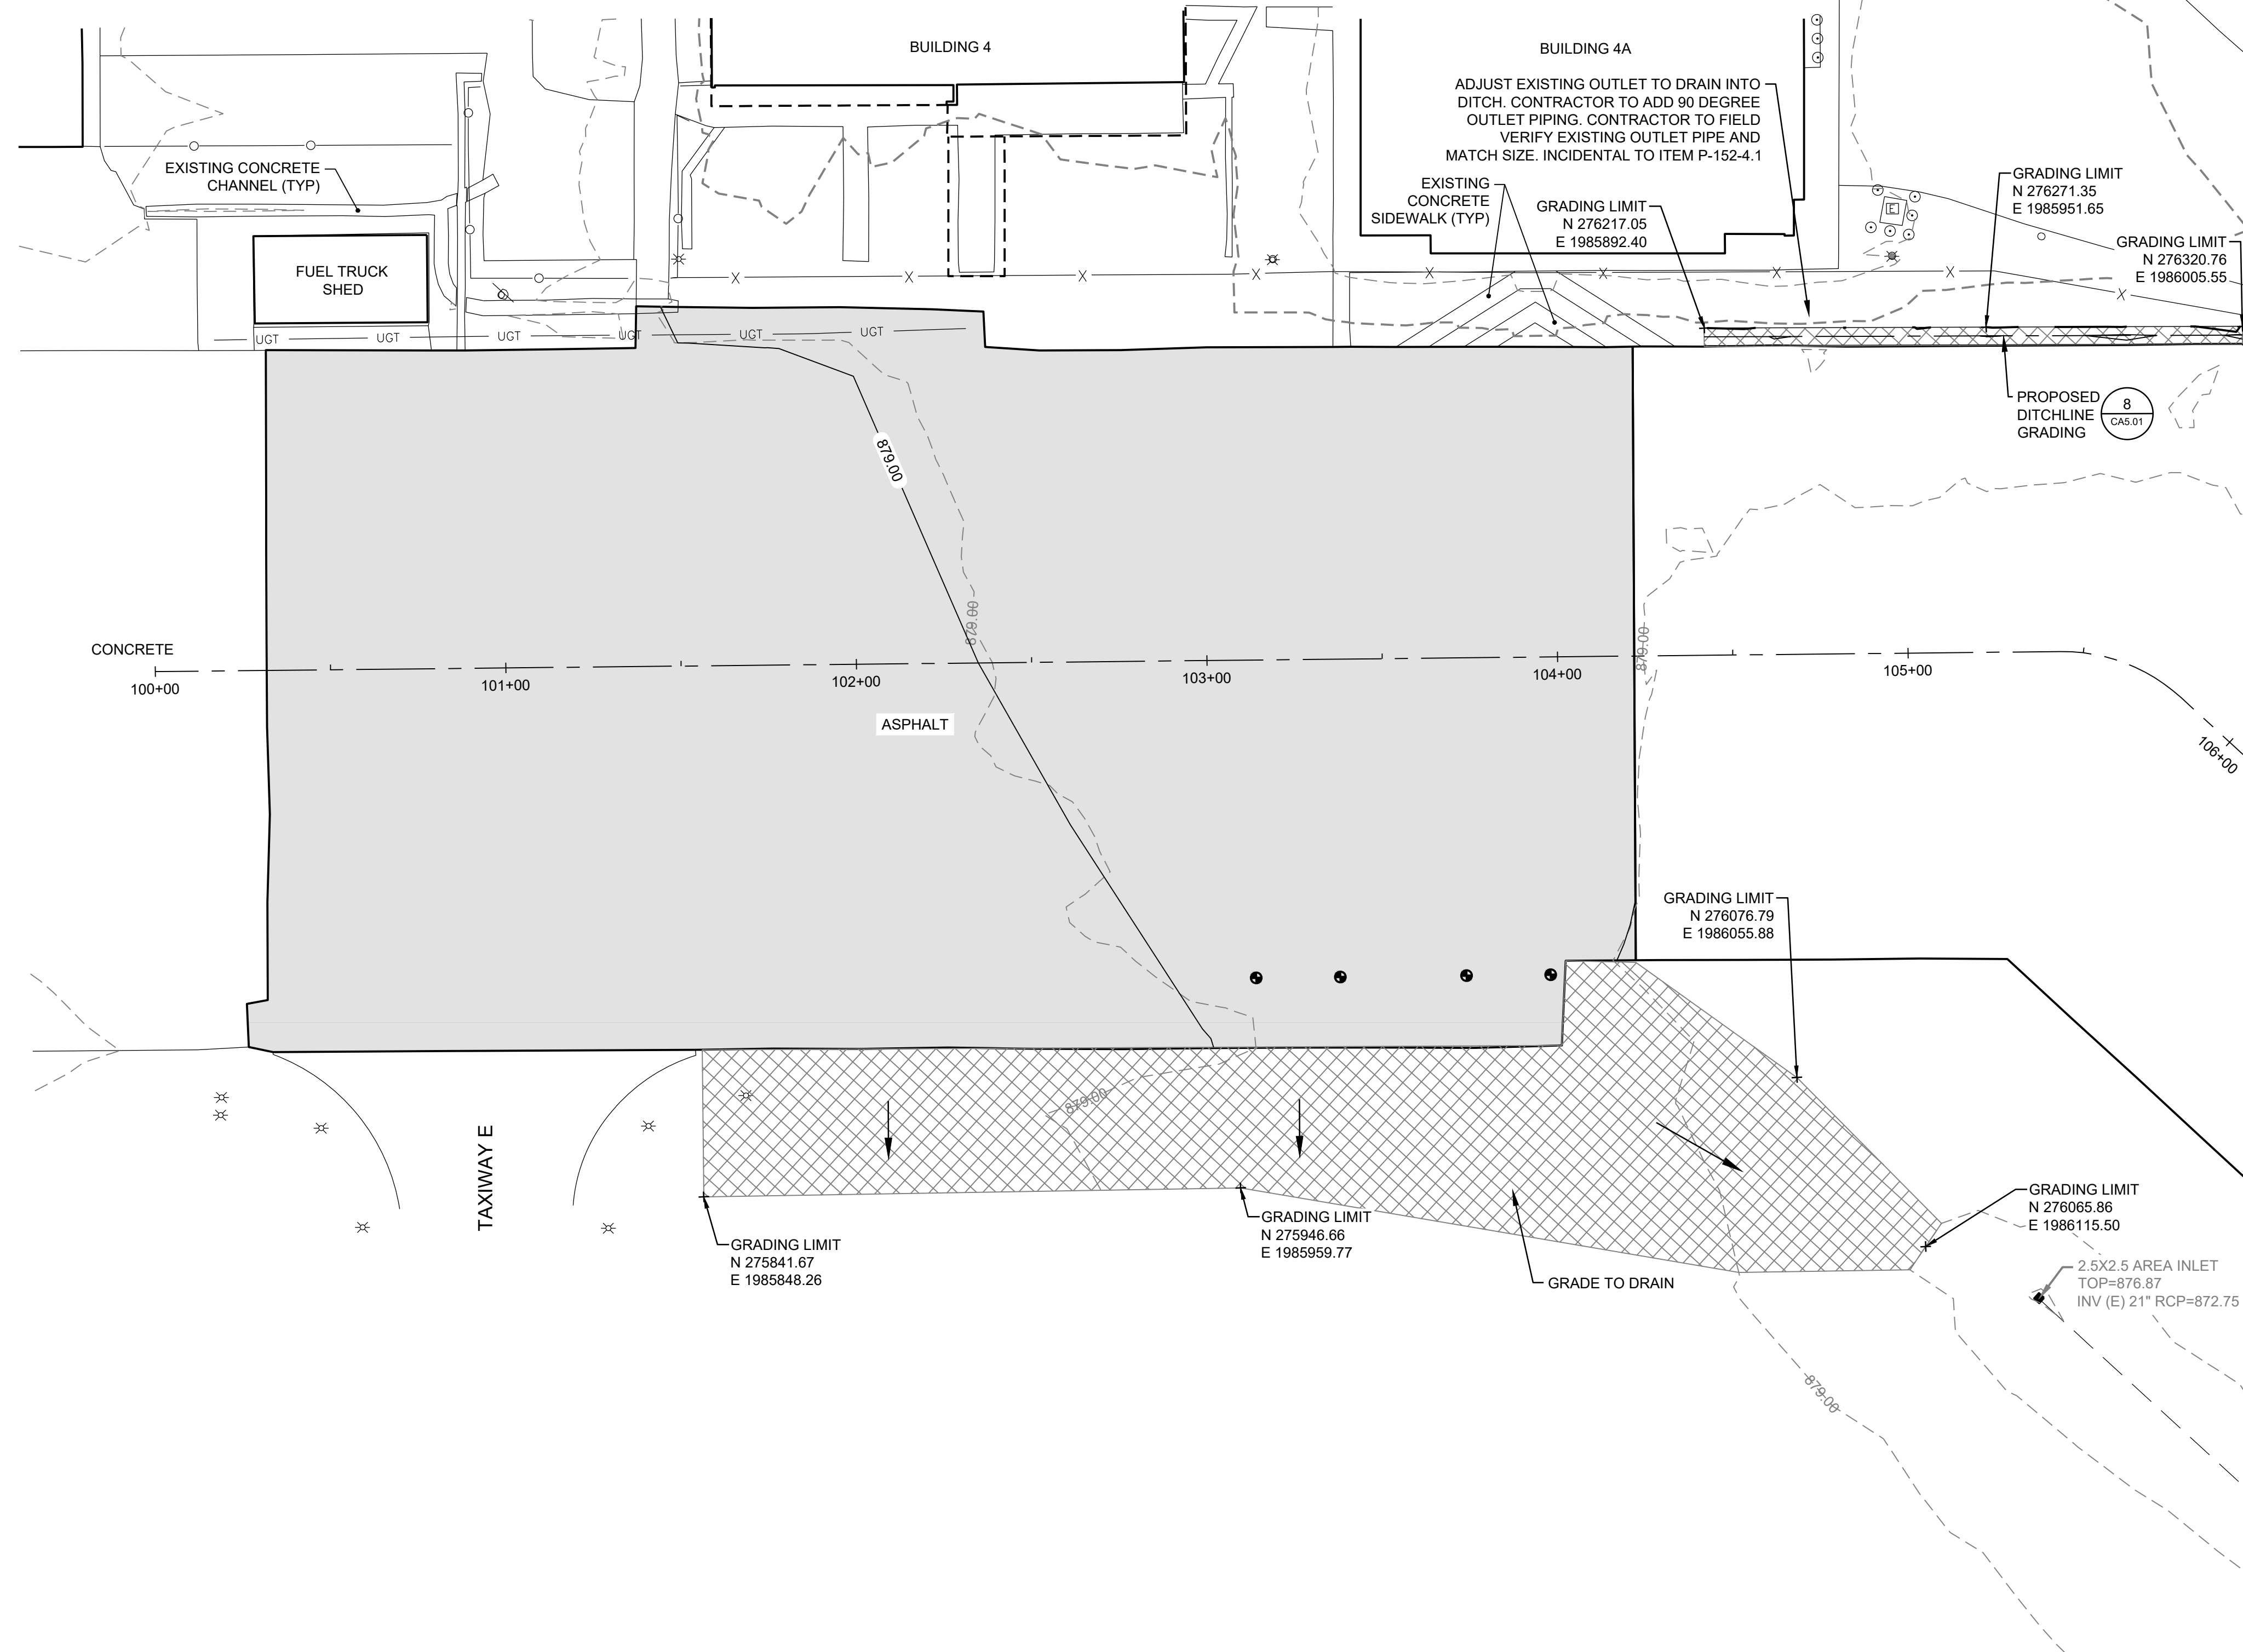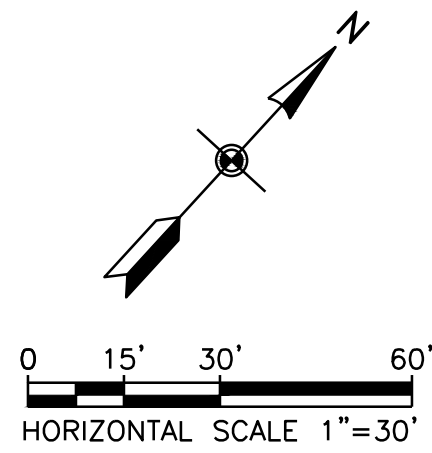

LEGEND

- DRAINAGE IMPROVEMENTS (ITEM P-152-4.1)
- ASPHALT OVERLAY (ITEM P-401-8.2)
- EXISTING MINOR CONTOUR
- EXISTING MAJOR CONTOUR
- PROPOSED MINOR CONTOUR
- PROPOSED MAJOR CONTOUR
- APPROXIMATE LIMITS OF DISTURBANCE

GENERAL NOTES:

1. CONTRACTOR TO FIELD VERIFY THE AS-BUILT ELEVATIONS OF THE RIM PRIOR TO COMMENCING PROCUREMENT AND SHOP DRAWING PRODUCTION OF DRAINAGE STRUCTURE ADJUSTMENT. THE CONTRACTOR MUST PROVIDE ANY DISCREPANCIES BETWEEN THE DESIGN ELEVATIONS SHOWN AND THE AS-BUILT ELEVATIONS TO MTAA.
2. CONTRACTOR TO VERIFY LOCATION OF EXISTING DRAINAGE INLET PRIOR TO PREPARATION OF SHOP DRAWINGS. THIS INFORMATION MUST BE PROVIDED TO MTAA UPON FIELD VERIFICATION.

METROPOLITAN TOPEKA AIRPORT AUTHORITY

**PHILIP BILLARD MUNICIPAL AIRPORT
 TERMINAL APRON REHABILITATION**

AIP CONSTRUCTION GRANT NO. 3-20-0082-027
 BIL-AIG CONSTRUCTION GRANT NO. 3-20-0082-028

NO.	DATE	BY	DESCRIPTION

ISSUED FOR BID


SHEET TITLE
**GRADING PLAN
 SHEET 1 OF 2**

DATE **FEBRUARY 14, 2025**
 SCALE **1" = 30'**
 DRAWN BY **BF**
 CHECKED BY **LDS**
 APPROVED BY **SFS**




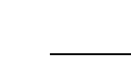



WSP PROJECT NUMBER **US0040451.4453**

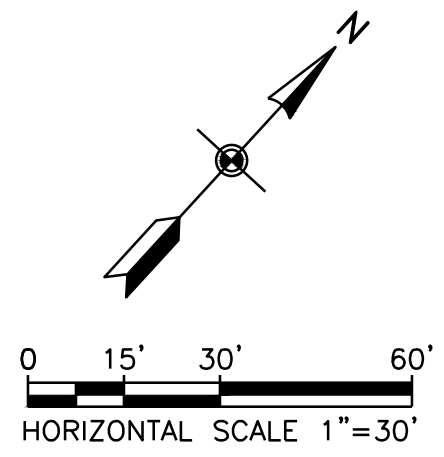SHEET NUMBER **CG1.01**

SHEET **17 OF 22**




LEGEND

-  DRAINAGE IMPROVEMENTS (ITEM P-152-4.1)
-  ASPHALT OVERLAY (ITEM P-401-8.2)
-  EXISTING MINOR CONTOUR
-  EXISTING MAJOR CONTOUR
-  PROPOSED MINOR CONTOUR
-  PROPOSED MAJOR CONTOUR
-  APPROXIMATE LIMITS OF DISTURBANCE

GENERAL NOTES:

1. CONTRACTOR TO FIELD VERIFY THE AS-BUILT ELEVATIONS OF THE RIM PRIOR TO COMMENCING PROCUREMENT AND SHOP DRAWING PRODUCTION OF DRAINAGE STRUCTURE ADJUSTMENT. THE CONTRACTOR MUST PROVIDE ANY DISCREPANCIES BETWEEN THE DESIGN ELEVATIONS SHOWN AND THE AS-BUILT ELEVATIONS TO MTA.
2. CONTRACTOR TO VERIFY LOCATION OF EXISTING DRAINAGE INLET PRIOR TO PREPARATION OF SHOP DRAWINGS. THIS INFORMATION MUST BE PROVIDED TO MTA UPON FIELD VERIFICATION.

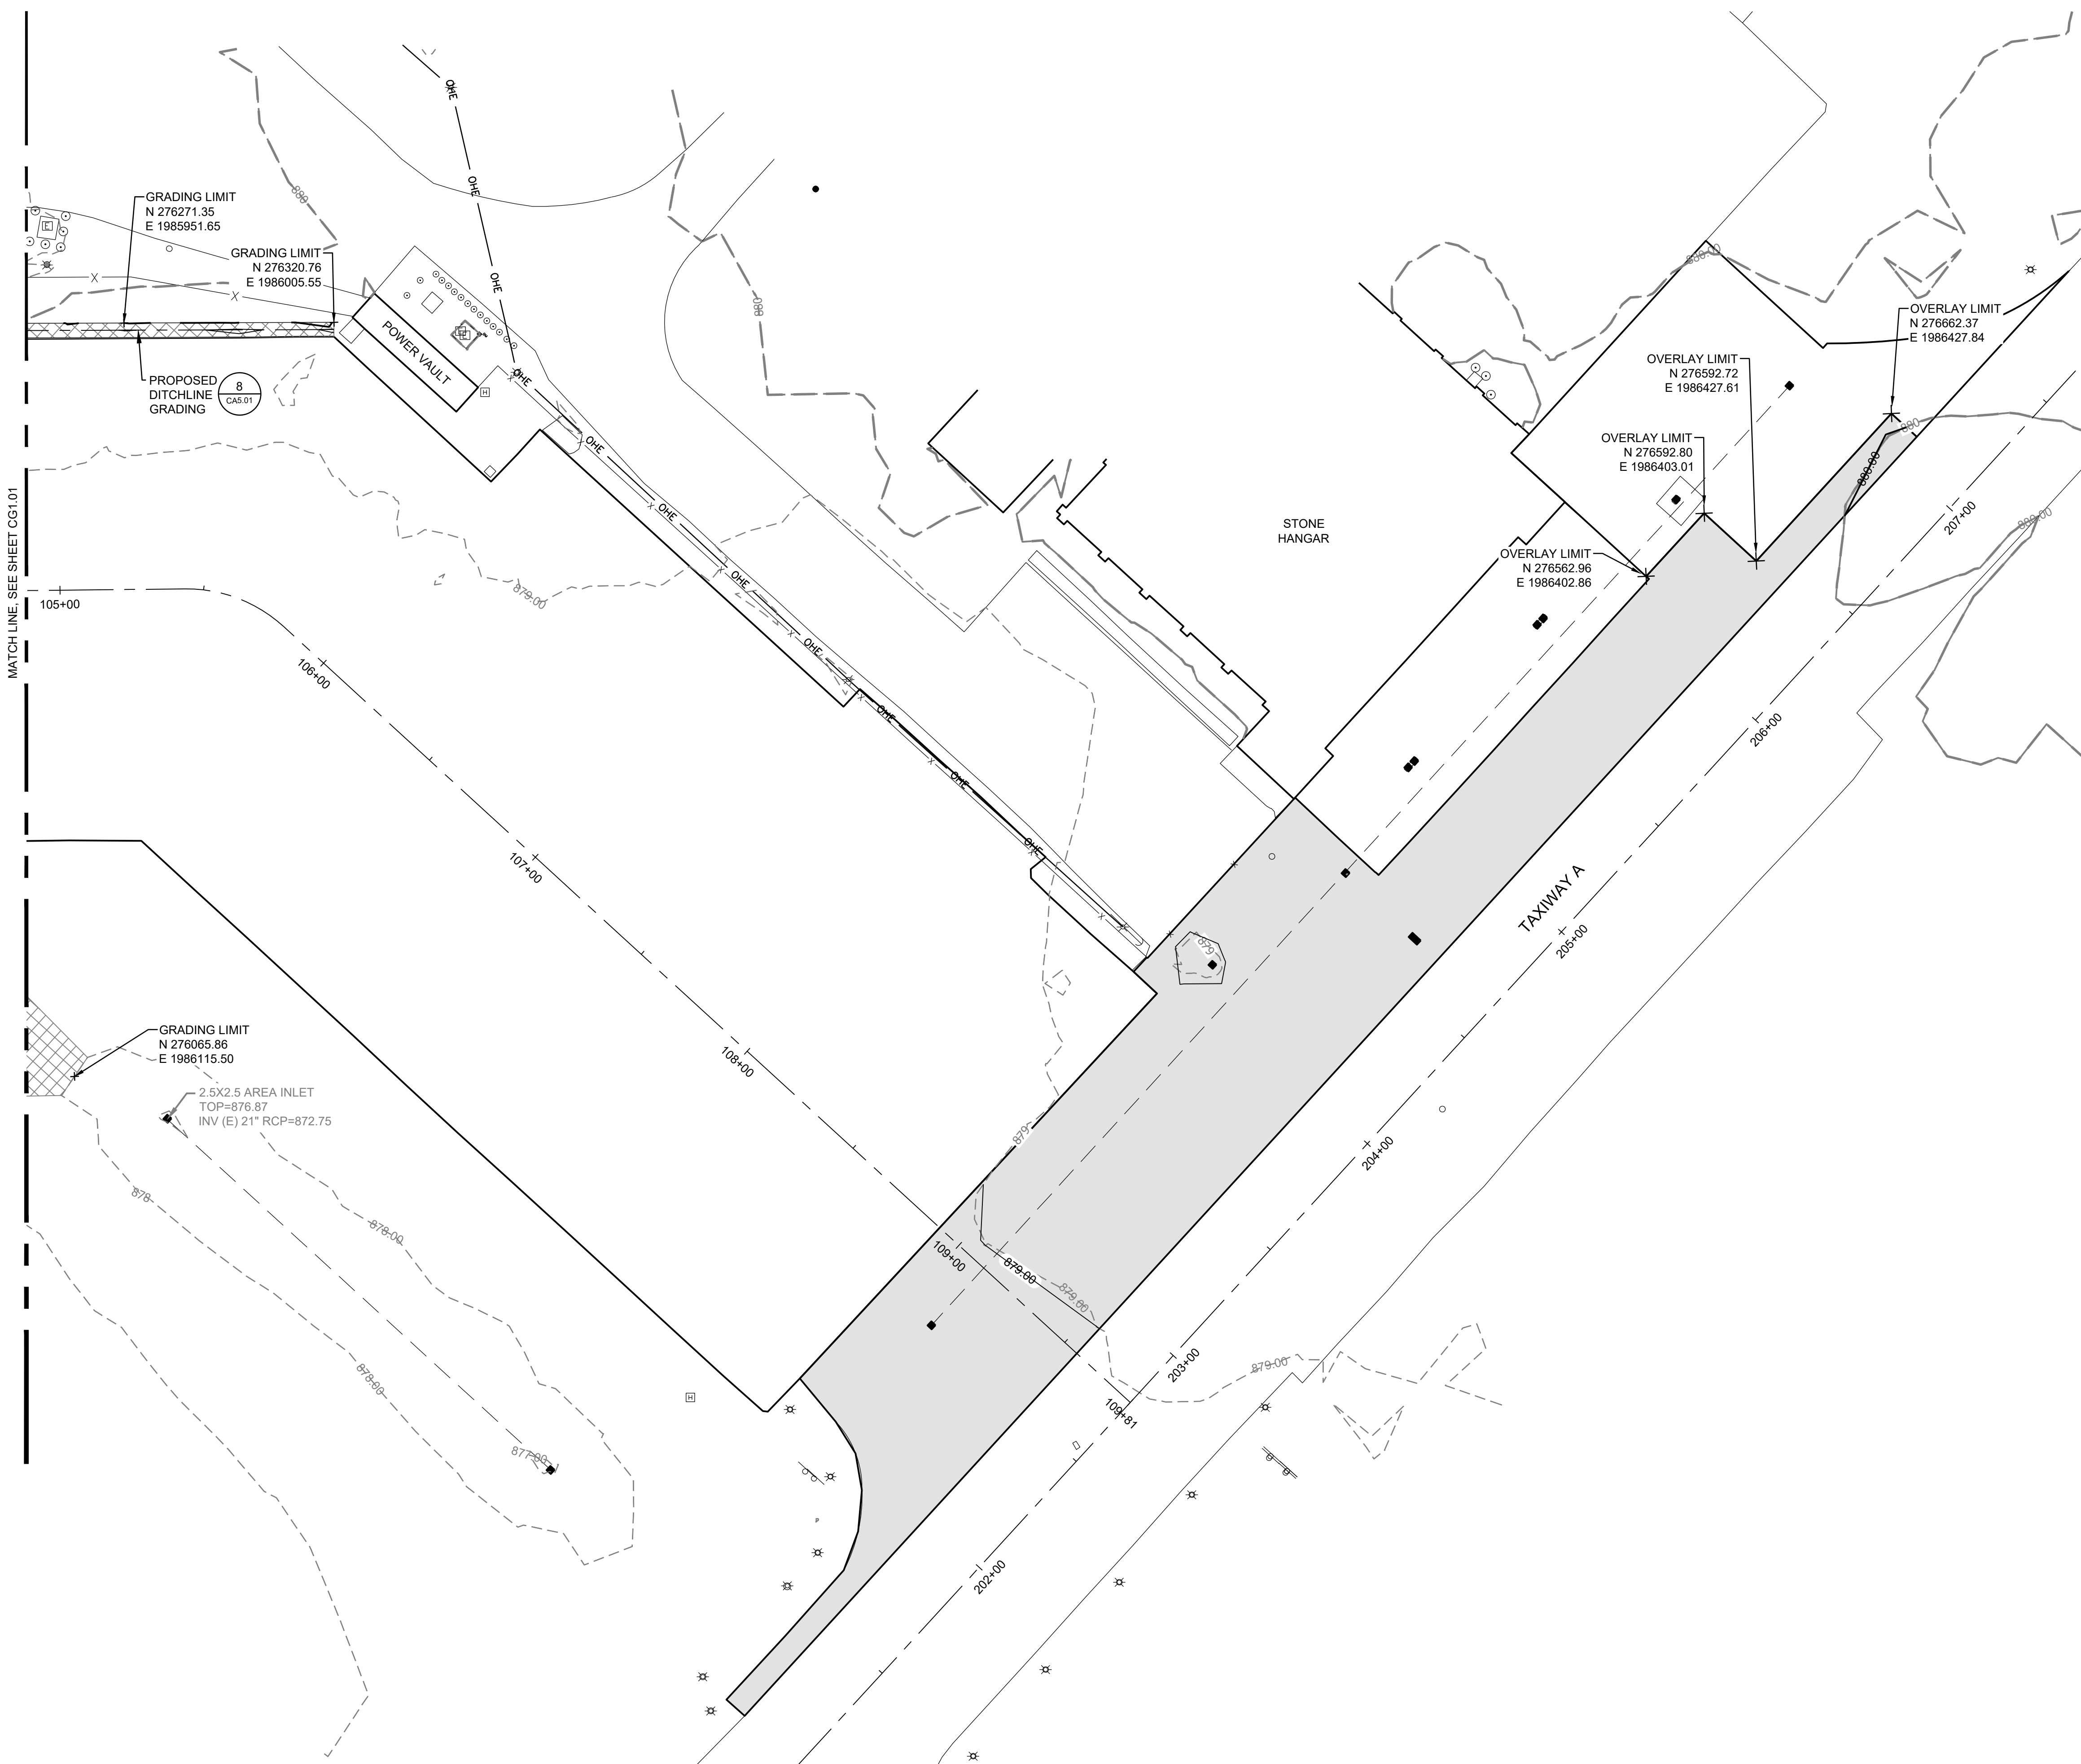

MATCH LINE, SEE SHEET CG1.01

FILE NAME: US0040451.4453-CG1.DWG
 PLOT DATE: Feb 14, 2025 - 11:41AM

METROPOLITAN TOPEKA AIRPORT AUTHORITY

**PHILIP BILLARD MUNICIPAL AIRPORT
 TERMINAL APRON REHABILITATION**

AIP CONSTRUCTION GRANT NO. 3-20-0082-027
 BIL-AIG CONSTRUCTION GRANT NO. 3-20-0082-028

NO.	DATE	BY	DESCRIPTION

ISSUED FOR BID

SHEET TITLE
**GRADING PLAN
 SHEET 2 OF 2**


DATE **FEBRUARY 14, 2025**
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 DRAWN BY **BF**
 CHECKED BY **LDS**
 APPROVED BY **SFS**

WSP PROJECT NUMBER **US0040451.4453**

SHEET NUMBER **CG1.02**

SHEET **18 OF 22**

SCALE (S) AS NOTED ON THIS SHEET ARE BASED ON A FULL SIZE 22 X 34 SHEET

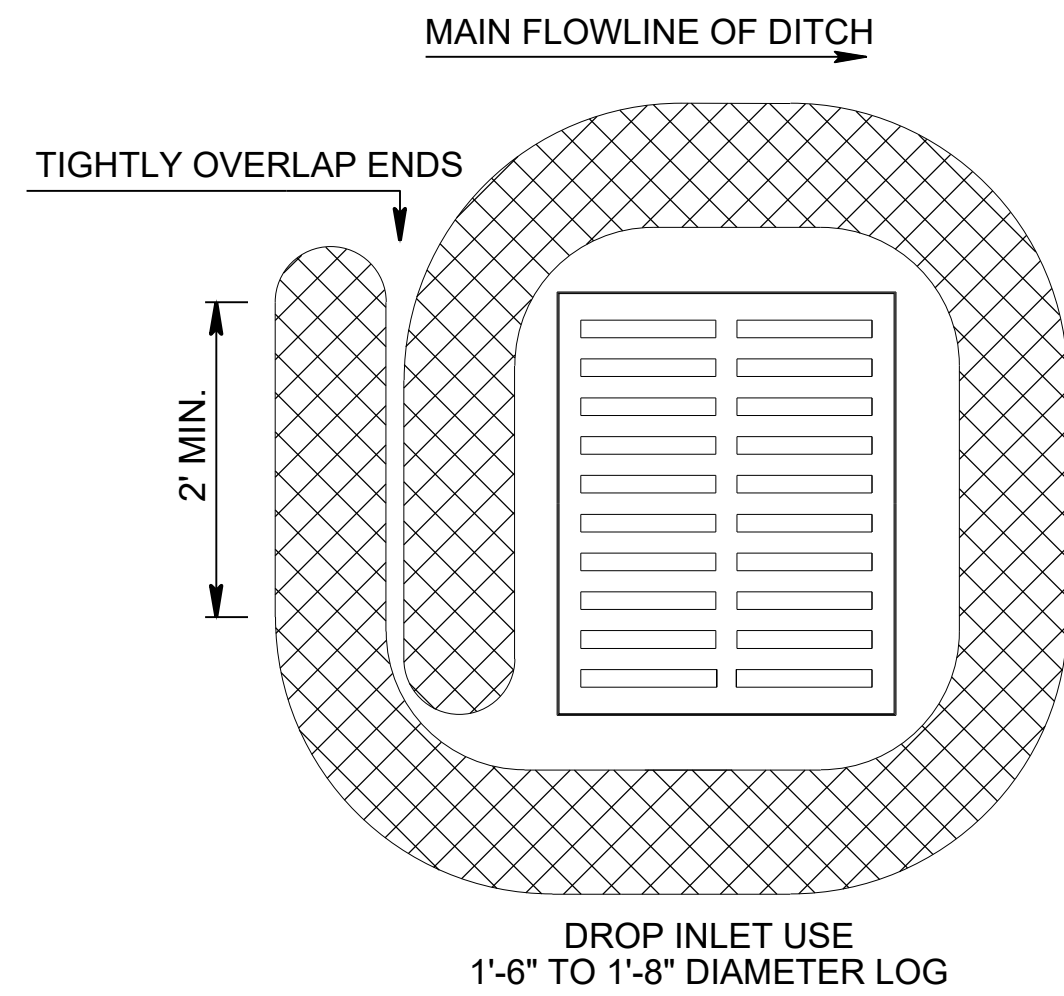

NOTE: 25% OF LOG SHALL BE KEYPED INTO GROUND DURING INSTALLATION.
STAKE EVERY 4'

MATERIAL REQUIREMENTS
USE 100% SHREDDED MULCH OR OTHER NON-COMPOST BIODEGRADABLE MATERIAL AS FILL FOR LOGS.
NO COMPOST OR FINES.
NO HAY OR STRAW.
DO NOT USE MATERIAL WHICH PROHIBITS WATER INFILTRATION.
LOG MESH: USE MESH WITH 1/4" OPENINGS OR LARGER. MESH MUST ALLOW WATER INFILTRATION BUT ALSO HOLD FILL MATERIAL IN PLACE.

1
CE5.01 BIODEGRADABLE LOG/FILTER SOCK
DROP INLET PROTECTION
SCALE: 1" = 20'

GENERAL NOTES

THE ENTIRE DISTURBED AREA, EXCEPTING THE PAVED OR SURFACED AREAS, STEEP ROCKY SLOPES AND AREAS OF UNDISTURBED NATIVE SOD OR OTHER DESIRABLE VEGETATION SHALL BE FERTILIZED (LIMED WHEN REQUIRED), SEEDED, AND MULCHED. SOIL PREPARATION SHALL CONFORM TO THE STANDARD SPECIFICATIONS.

PERMANENT SEEDING SHALL BE DONE DURING THE NORMAL SEEDING SEASON.

MULCHING: MULCH SHALL BE SPREAD UNIFORMLY OVER ALL DISTURBED AREAS AND PUNCHED IN THE SOIL, UNLESS OTHERWISE NOTED ON THE PLANS. THE RATE OF APPLICATION PER ACRE, THICKNESS IN PLACE, FOR THE MULCHING MATERIALS IS AS FOLLOWS:

1 3/4 - 2 1/4 TONS PER ACRE = 1 1/2 LOOSE DEPTH SPREAD UNIFORMLY OVER ACRE.

AGRICULTURAL PRODUCTS, SUCH AS NATIVE PRAIRIE HAY, USED FOR MULCHING AND EROSION CONTROL PRACTICES, EXCLUDING WOOD BASED MULCH, SHALL MEET THE NORTH AMERICAN WEED FREE FORAGE STANDARDS.

OTHER VEGETATIVE MULCHES ARE ACCEPTABLE ONLY WITH THE ENGINEER'S CONCURRENCE.

THE ABOVE RATE IS A GUIDE. IT WILL BE AT THE DISCRETION OF THE ENGINEER TO DETERMINE WHAT RATE IS SUFFICIENT FOR ADEQUATE PROTECTION OF NEWLY SEEDED AREAS.

THE AMOUNT OF MULCH AND MULCH TACKING SLURRY IN THE BID QUANTITIES IS ESTIMATED. THE TOTAL MULCH AND MULCH TACKING SLURRY REQUIRED SHALL BE DETERMINED IN THE FIELD. THE BID ITEM FOR MULCHING AND MULCH TACKING SLURRY SHALL BE PAID FOR ACCORDING TO THE STANDARD SPECIFICATIONS.

METROPOLITAN TOPEKA AIRPORT AUTHORITY

**PHILIP BILLARD MUNICIPAL AIRPORT
TERMINAL APRON REHABILITATION**

AIP CONSTRUCTION GRANT NO. 3-20-0082-027
BIL-AIG CONSTRUCTION GRANT NO. 3-20-0082-028

NO.	DATE	BY	DESCRIPTION

ISSUED FOR BID



SHEET TITLE
EROSION CONTROL DETAILS

DATE **FEBRUARY 20, 2025**
SCALE **NTS**
DRAWN BY **BF**
CHECKED BY **LDS**
APPROVED BY **SFS**

WSP PROJECT NUMBER **US0040451.4453**

SHEET NUMBER **CE5.01**

SHEET **19** OF 22

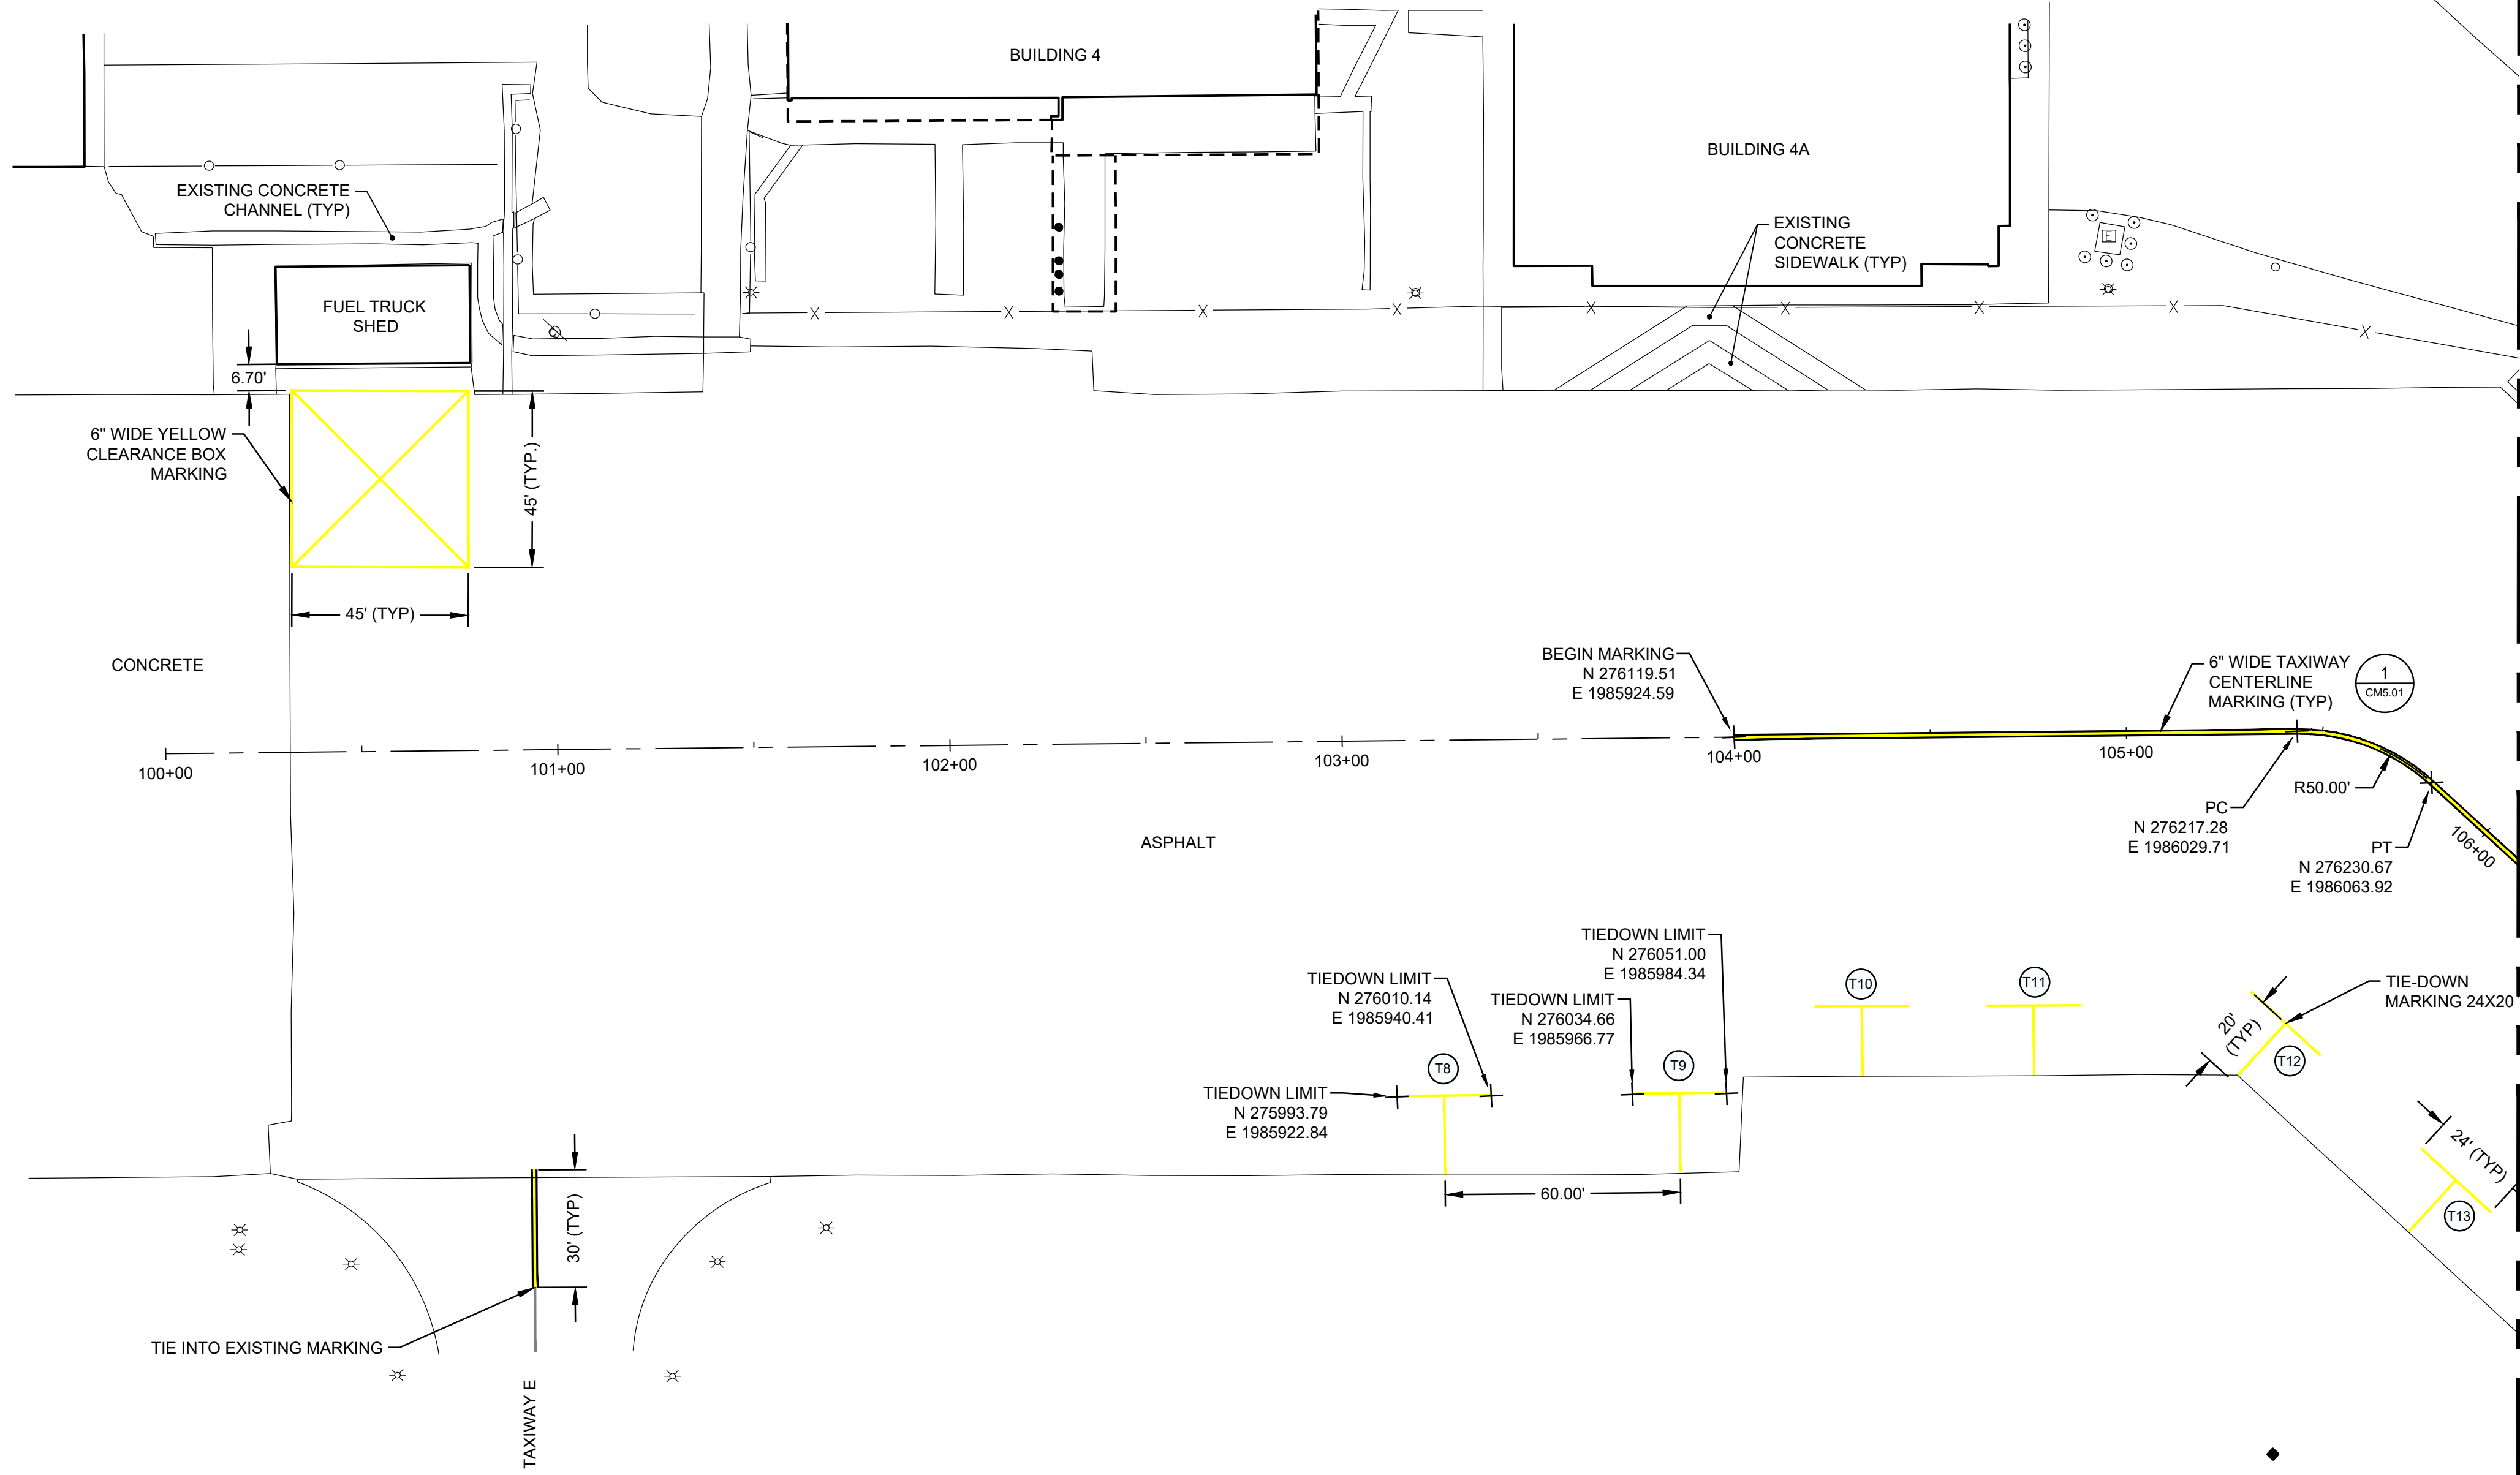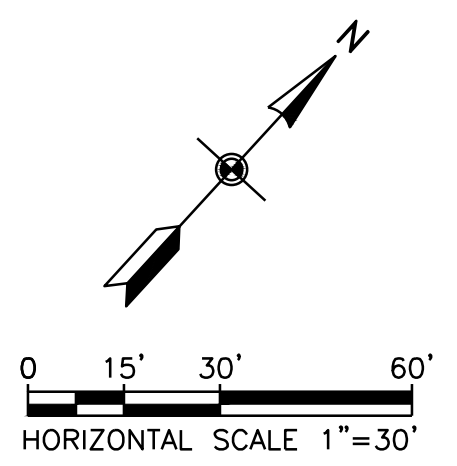

LEGEND

- TAXIWAY CENTERLINE MARKING
- TAXIWAY EDGE MARKINGS
- TIEDOWN IDENTIFICATION NUMBER

NOTES:

1. TAXIWAY CENTERLINE, DASHED AND CONTINUOUS TAXIWAY EDGE MARKINGS SHALL RECEIVE 6" BLACK BORDER (ITEM P-620-5.4). SEE SHEET CM5.01 FOR DETAILS.
2. CLEARANCE BOX, CENTERLINE, DASHED AND CONTINUOUS TAXIWAY EDGE MARKINGS SHALL RECEIVE TEMPORARY PAINT APPLICATION (ITEM P-620-5.3).
3. YELLOW PERMANENT PAVEMENT MARKINGS SHALL RECEIVE GLASS BEADS (ITEM P-620-5.3).
4. ALL MARKINGS SHALL CONFORM TO FAA ADVISORY CIRCULAR 150/5340-1 (LATEST VERSION).
5. TIEDOWN MARKINGS "T1" THROUGH "T7" AND "T10" THROUGH "T16" TO MATCH EXISTING TIE-DOWN ANCHOR LAYOUT
6. TIE DOWN MARKING "T8" AND "T9" ARE TO BE INSTALLED AT NEW TIEDOWN LOCATIONS SEE SHEET CA1.01.

MATCHLINE SEE SHEET CM1.02

FILE NAME: US0040451.4453-CM1.DWG
 PLOT DATE: Feb 14, 2025 - 9:22AM

METROPOLITAN TOPEKA AIRPORT AUTHORITY

**PHILIP BILLARD MUNICIPAL AIRPORT
 TERMINAL APRON REHABILITATION**

AIP CONSTRUCTION GRANT NO. 3-20-0082-027
 BIL-AIG CONSTRUCTION GRANT NO. 3-20-0082-028

NO.	DATE	BY	DESCRIPTION

ISSUED FOR BID

SHEET TITLE
**PAVEMENT MARKING PLAN
 SHEET 1 OF 2**


DATE: **FEBRUARY 14, 2025**
 SCALE: **1" = 30'**
 DRAWN BY: **BF**
 CHECKED BY: **LDS**
 APPROVED BY: **SFS**

WSP PROJECT NUMBER **US0040451.4453**

SHEET NUMBER **CM1.01**

SHEET **20** OF **22**

SCALE (S) AS NOTED ON THIS SHEET ARE BASED ON A FULL SIZE 22 X 34 SHEET

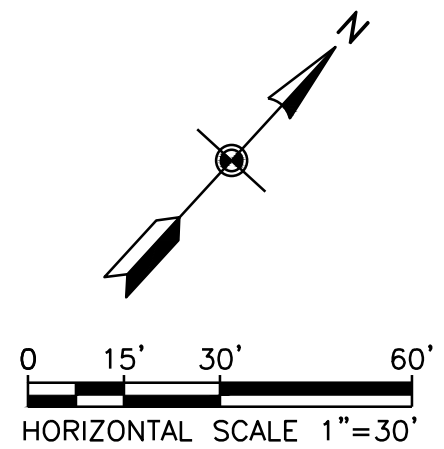


LEGEND

- TAXIWAY CENTERLINE MARKING
- TAXIWAY EDGE MARKINGS
- TIEDOWN IDENTIFICATION NUMBER
- PAVEMENT MARKING REMOVAL

NOTES:

1. TAXIWAY CENTERLINE, DASHED AND CONTINUOUS TAXIWAY EDGE MARKINGS SHALL RECEIVE 6" BLACK BORDER (ITEM P-620-5.4). SEE SHEET CM5.01 FOR DETAILS.
2. CLEARANCE BOX, CENTERLINE, DASHED AND CONTINUOUS TAXIWAY EDGE MARKINGS SHALL RECEIVE TEMPORARY PAINT APPLICATION (ITEM P-620-5.3).
3. YELLOW PERMANENT PAVEMENT MARKINGS SHALL RECEIVE GLASS BEADS (ITEM P-620-5.3).
4. ALL MARKINGS SHALL CONFORM TO FAA ADVISORY CIRCULAR 150/5340-1 (LATEST VERSION).
5. TIEDOWN MARKINGS "T1" THROUGH "T7" AND "T10" THROUGH "T16" TO MATCH EXISTING TIE-DOWN ANCHOR LAYOUT
6. TIE DOWN MARKING "T8" AND "T9" ARE TO BE INSTALLED AT NEW TIEDOWN LOCATIONS SEE SHEET CA 1.01.

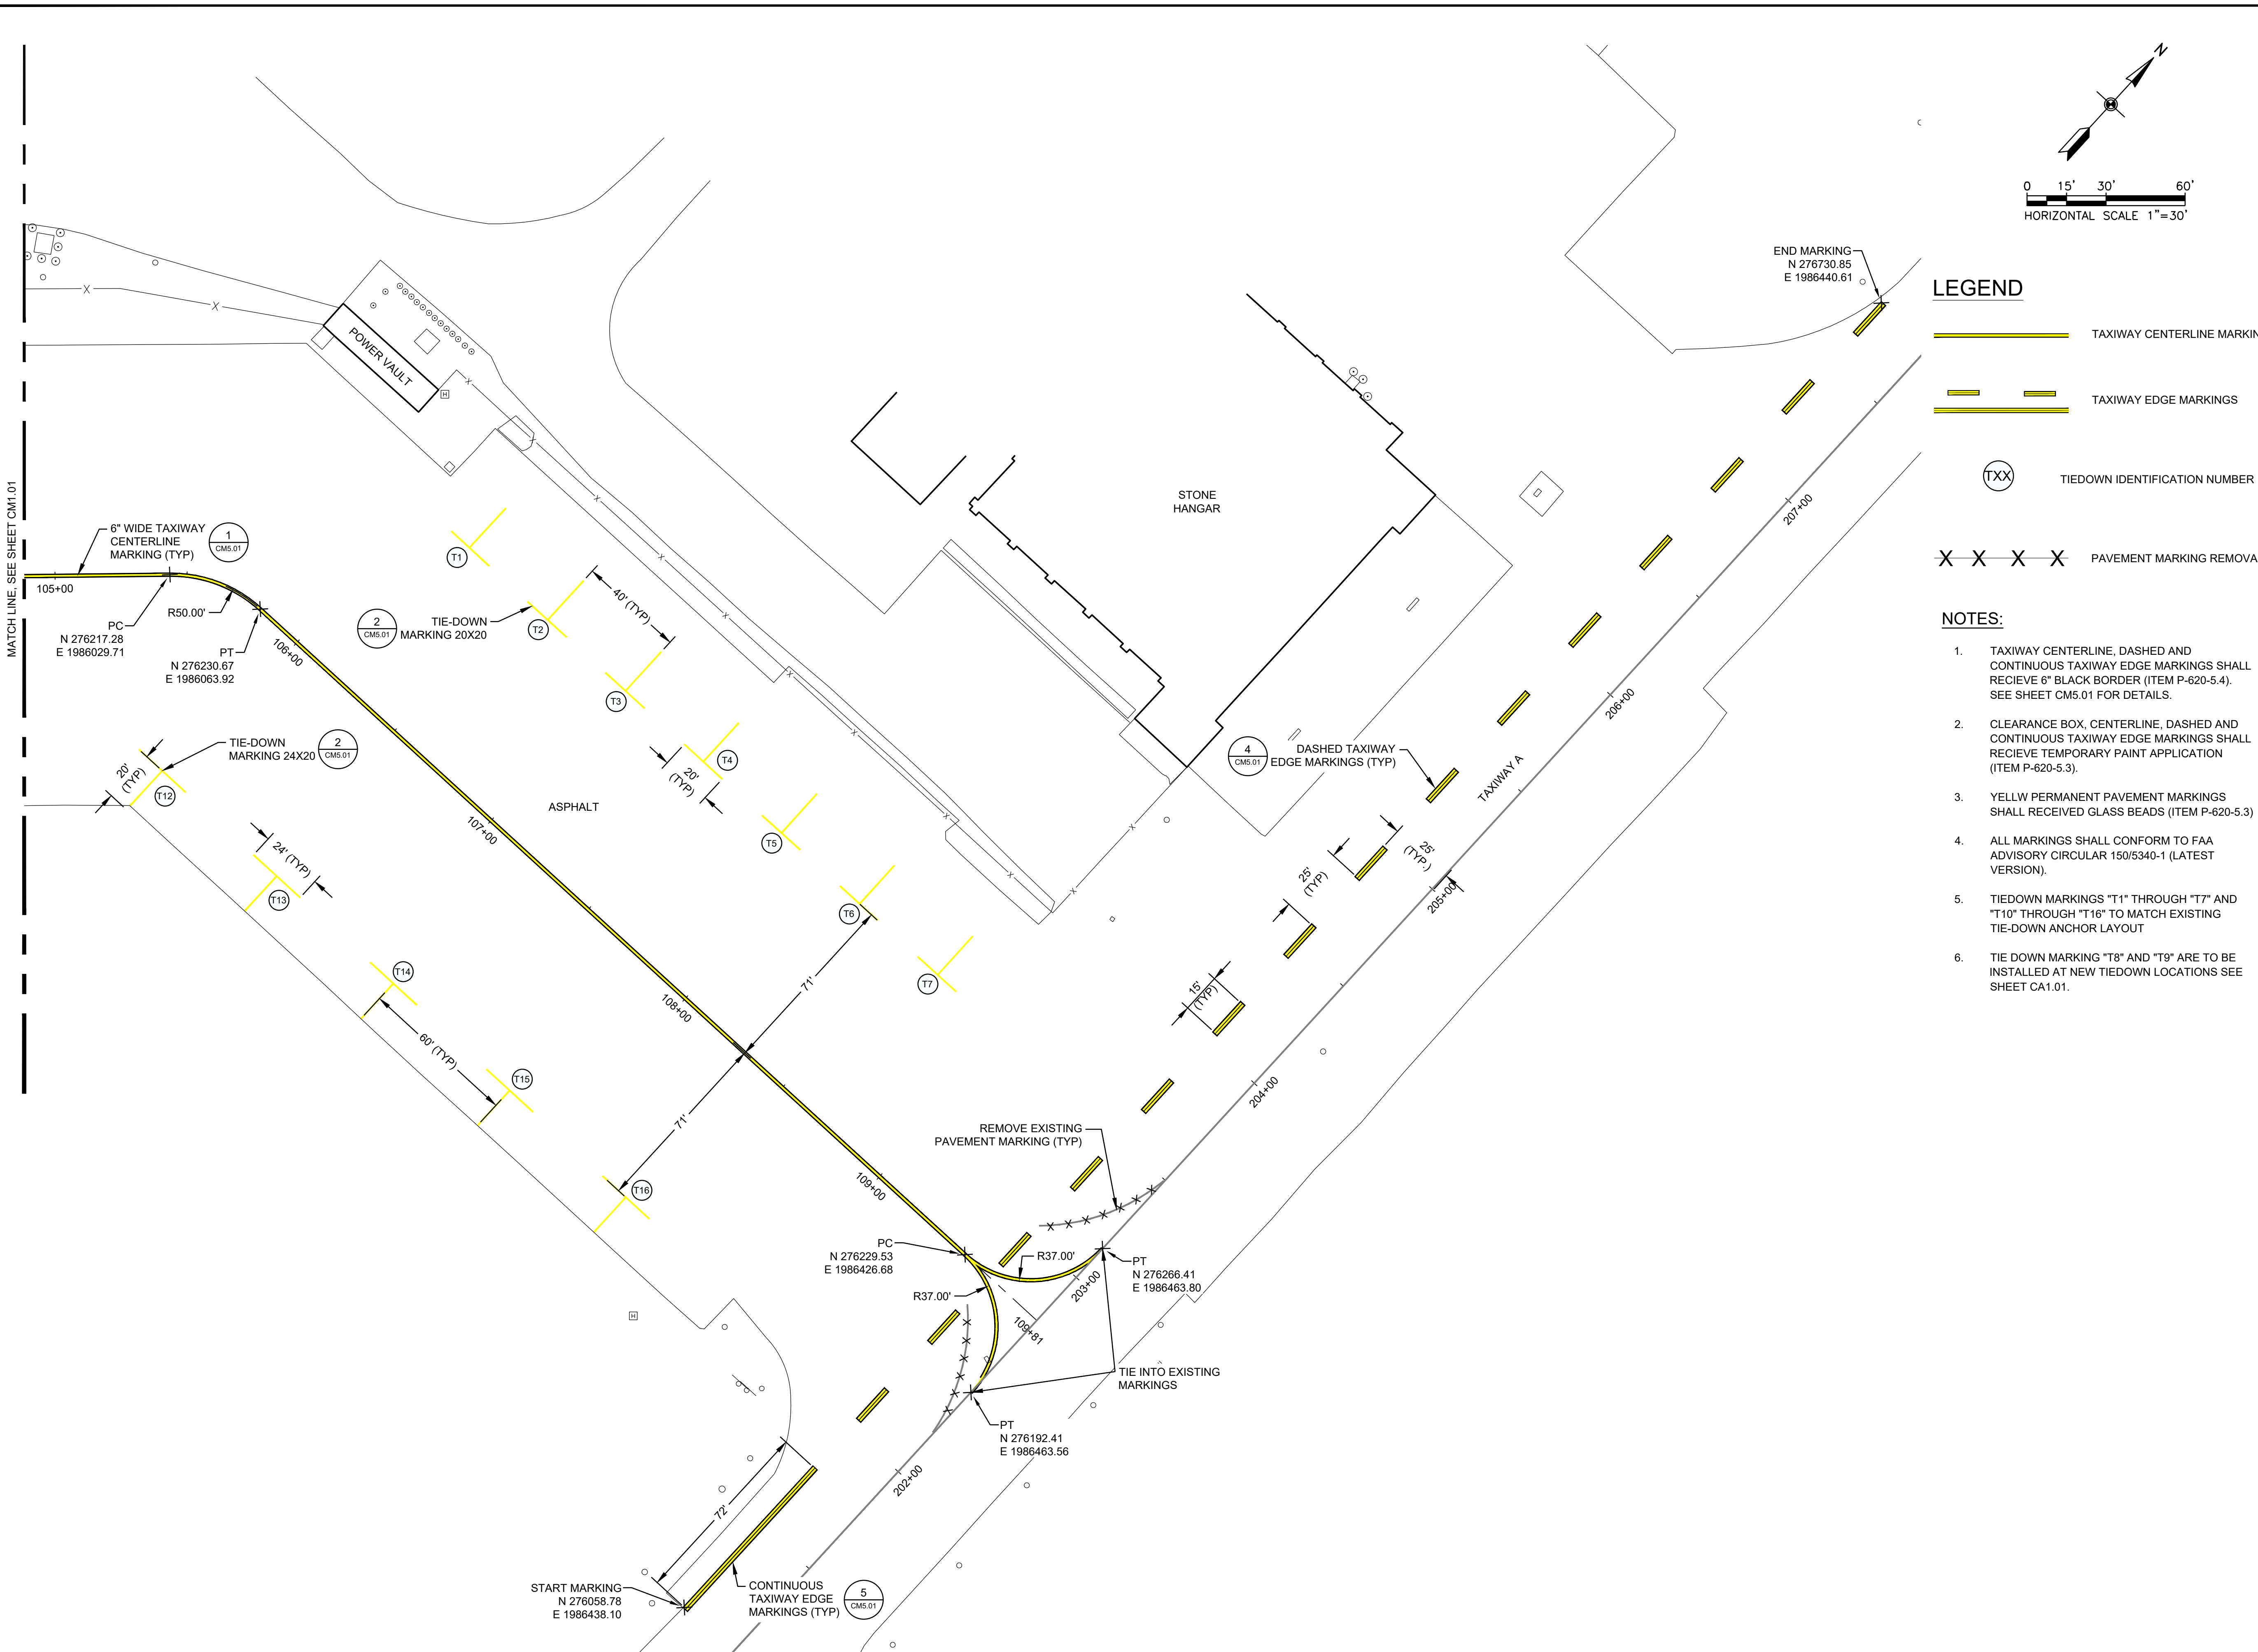

METROPOLITAN TOPEKA AIRPORT AUTHORITY
PHILIP BILLARD MUNICIPAL AIRPORT
TERMINAL APRON REHABILITATION
 AIP CONSTRUCTION GRANT NO. 3-20-0082-027
 BIL-AIG CONSTRUCTION GRANT NO. 3-20-0082-028

NO.	DATE	BY	DESCRIPTION

ISSUED FOR BID


SHEET TITLE
PAVEMENT MARKING PLAN
 SHEET 2 OF 2

DATE	FEBRUARY 14, 2025
SCALE	1" = 30'
DRAWN BY	BF
CHECKED BY	LDS
APPROVED BY	SFS

WSP PROJECT NUMBER US0040451.4453

SHEET NUMBER **CM1.02**


SHEET 21 OF 22

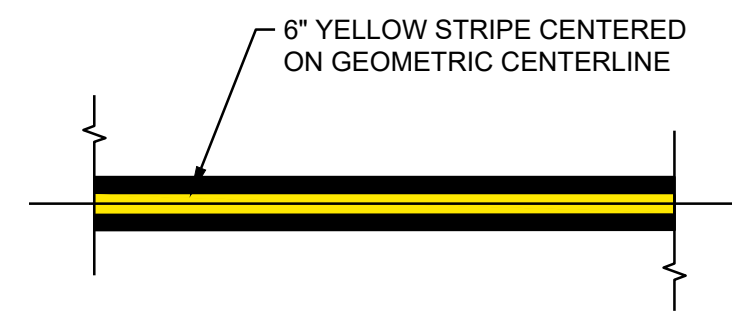


1 TAXIWAY CENTERLINE MARKING
 CM5.01 SCALE: NTS

NOTES:

1. ALL MARKINGS MUST CONFORM TO FAA ADVISORY CIRCULAR 150/5340-1M.
2. ALL MARKINGS SHALL BE OUTLINED WITH BLACK. SPACES BETWEEN PAINT LINES ARE PAINTED IN BLACK. PAINT EXTENDS AT LEAST 6" BEYOND THE OUTSIDE EDGE OF THE MARKINGS.

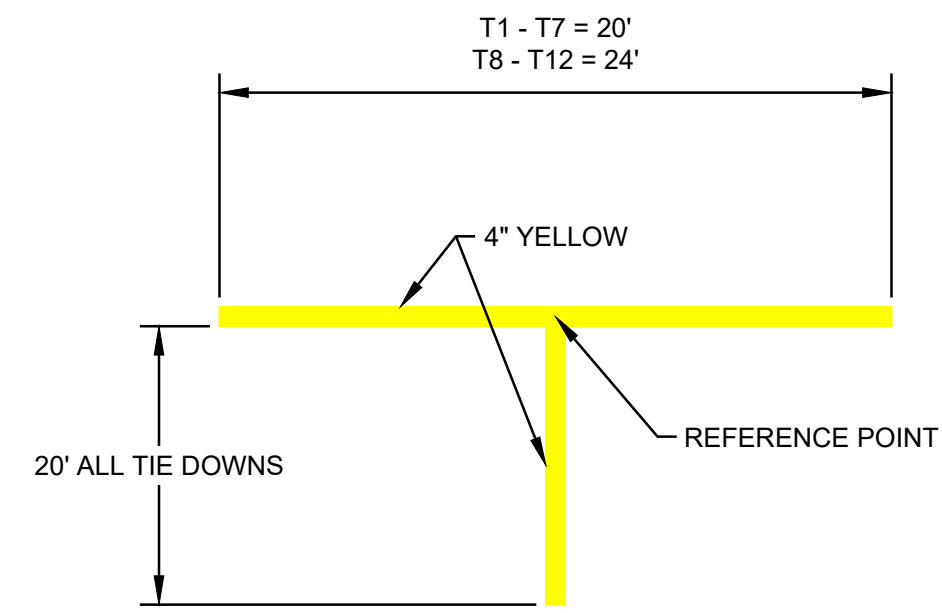


2 AIRCRAFT PARKING TEE MARKING
 CM5.01 SCALE: NTS

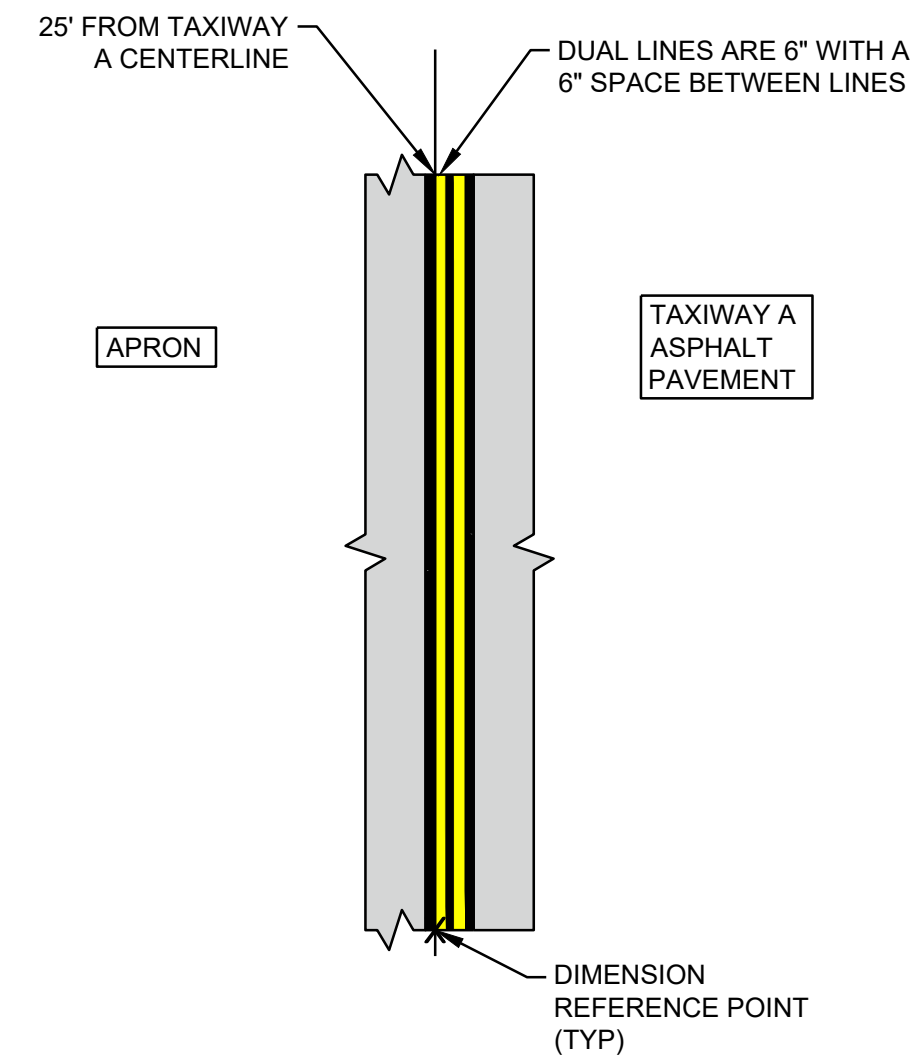

3 CONTINUOUS TAXIWAY EDGE MARKING
 CM5.01 SCALE: NTS

NOTES:

1. ALL MARKINGS MUST CONFORM TO FAA ADVISORY CIRCULAR 150/5340-1M.
2. ALL PAVEMENT MARKINGS ON P.C.C. AND ASPHALTIC CONCRETE PAVEMENT MUST BE OUTLINED WITH A 6" WIDE BLACK BORDER.

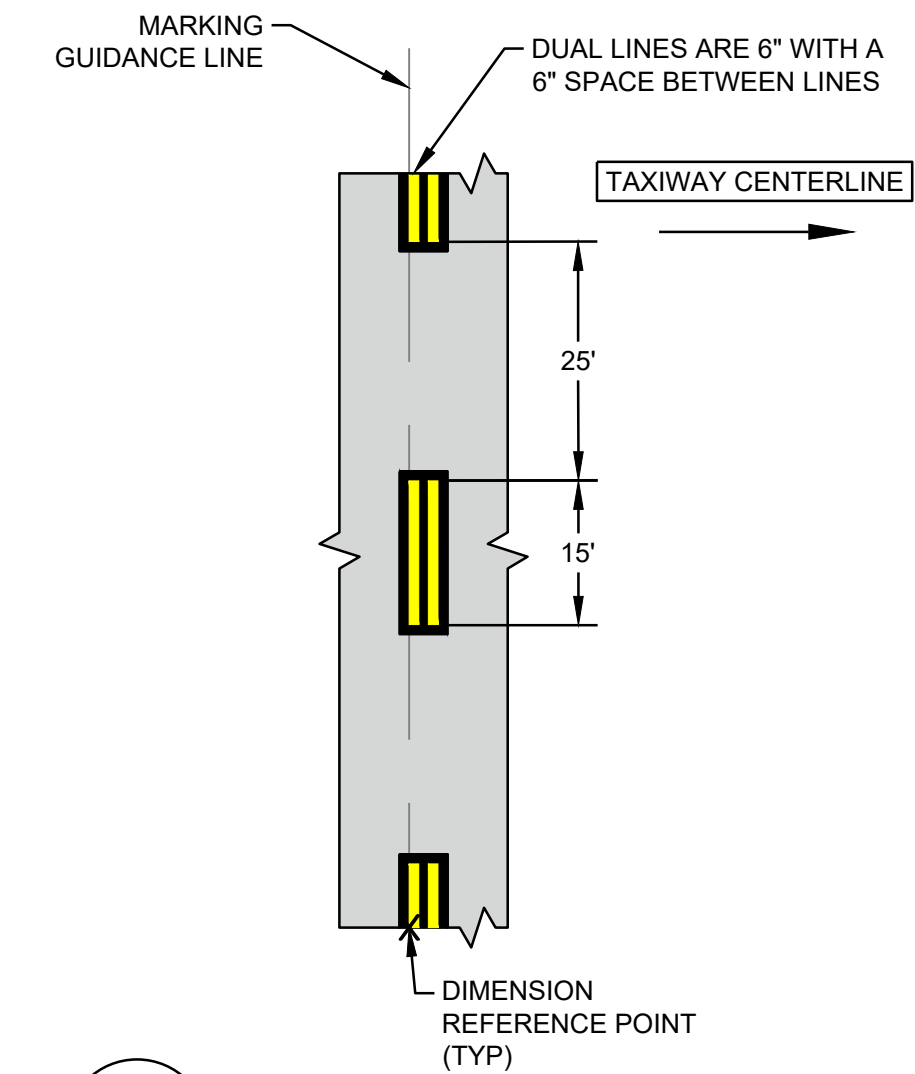

4 DASHED TAXIWAY EDGE MARKING
 CM5.01 SCALE: NTS

NOTES:

1. USE ONLY AS DIRECTED ON THE PLANS.
2. ALL MARKINGS SHALL CONFORM TO FAA ADVISORY CIRCULAR 150/5340-1M.
3. ALL PAVEMENT MARKINGS P.C.C AND ASPHALTIC CONCRETE PAVEMENT SHALL BE OUTLINES WITH A 6" WIDE BLACK BORDER.

METROPOLITAN TOPEKA AIRPORT AUTHORITY

**PHILIP BILLARD MUNICIPAL AIRPORT
 TERMINAL APRON REHABILITATION**

AIP CONSTRUCTION GRANT NO. 3-20-0082-027
 BIL-AIG CONSTRUCTION GRANT NO. 3-20-0082-028

NO.	DATE	BY	DESCRIPTION

ISSUED FOR BID

SHEET TITLE
**PAVEMENT MARKING
 DETAILS**

DATE **FEBRUARY 14, 2025**
 SCALE **NTS**
 DRAWN BY **BF**
 CHECKED BY **LDS**
 APPROVED BY **SFS**

WSP PROJECT NUMBER **US0040451.4453**

SHEET NUMBER **CM5.01**

SHEET **22** OF **22**